

Autodesk Docs: 12371016000 Stockton USD Weber Institute Gymnasium 0271016000-A-WEBER-INST-SITE.rvt 4/17/2025 7:30:44 AM

STOCKTON UNIFIED SCHOOL DISTRICT

# STOCKTON USD WEBER INSTITUTE GYMNASIUM

302 W WEBER AVE,  
STOCKTON, CA 95203



AGENCY  
APPROVAL:

REVIEWING AGENCIES  
STAMP HERE



DESIGN  
FOR  
GOOD

**HMC  
Architects**  
3271-016-000  
2101 CAPITOL AVENUE, SUITE 100,  
SACRAMENTO, CA 95816  
916.368.7990 / www.hmcarchitects.com

NOT FOR  
CONSTRUCTION

**PROJECT TEAM**

**OWNER**  
**STOCKTON UNIFIED SCHOOL DISTRICT**  
56 SOUTH LINCOLN STREET, STOCKTON, CA 95203  
(209) 953-7000

**ARCHITECT**  
**HMC ARCHITECTS**  
2101 CAPITOL AVENUE, SUITE 100, SACRAMENTO, CA 95816  
(916) 368-7990

**CIVIL ENGINEER**  
**MCR ENGINEERING, INC.**  
1242 DUPONT COURT, MANTECA, CA 95336

**LANDSCAPE**  
**ATLAS LAB, INC.**  
1610 R STREET, ST 300, SACRAMENTO, CA 95811

**MECHANICAL, ELECTRICAL & PLUMBING**  
**OPTIMIZED ENERGY & FACILITIES  
CONSULTING, INC.**  
5734 LONETREE BLVD, ROCKLIN, CA 95765  
(916) 626-5518

**STRUCTURAL ENGINEERING**  
**RW CONSULTING ENGINEERS, INC.**  
1450 HARBOR BLVD, SUITE F, WEST SACRAMENTO, CA 95891  
(916) 229-8345

FACILITY:  
**WEBER INSTITUTE OF APPLIED SCIENCES & TECHNOLOGY**  
**302 W WEBER AVE,**  
**STOCKTON, CA 95203**

PROJECT:  
**STOCKTON USD WEBER INSTITUTE GYMNASIUM**

SHEET NAME:  
**COVER SHEET**

**DESIGN DEVELOPMENT**

DATE: 04/18/2025	CLIENT PROJ NO:
SHEET:	

G0.10








VAN BUREN STREET

WEBER AVENUE

MADISON STREET

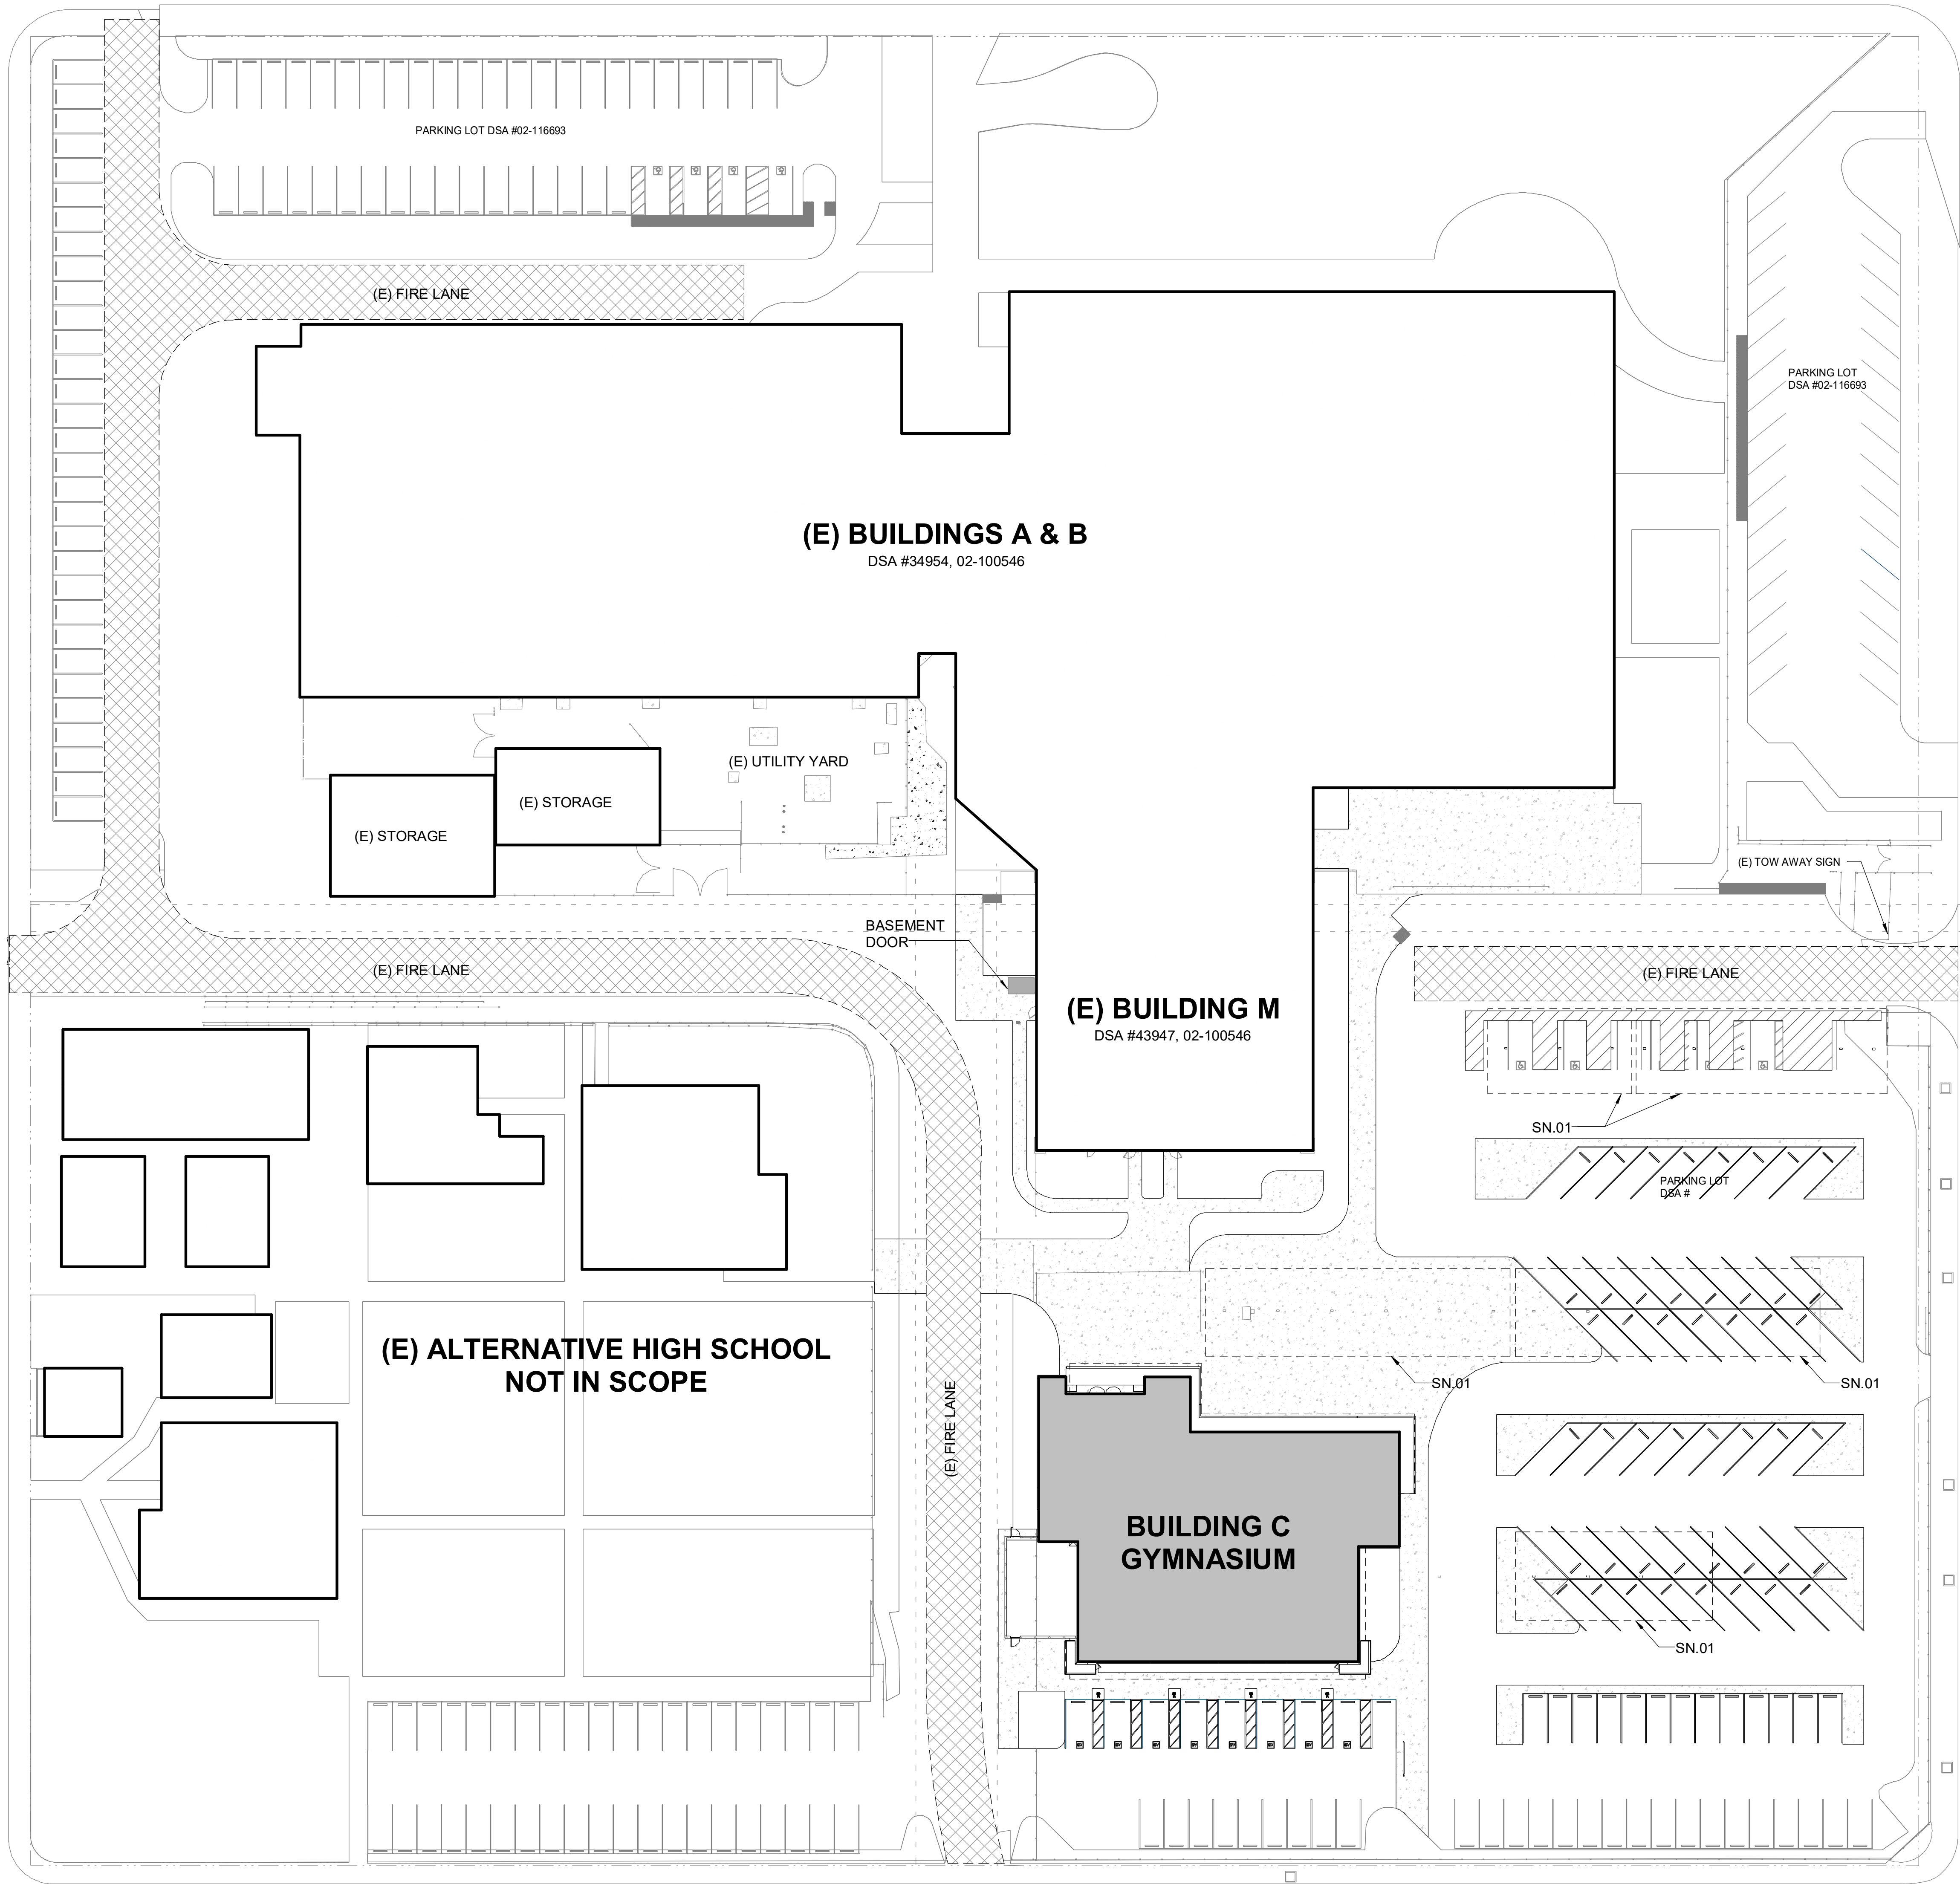

LEGEND

- APPROXIMATE LIMIT OF WORK. REFER TO ADDITIONAL DRAWINGS FOR WORK WHICH MAY EXTEND BEYOND THIS APPROXIMATE LIMIT OF WORK LINE.
- PROPERTY LINE
- EASEMENT LINE
- PATH OF TRAVEL
- NEW BUILDING
- EXISTING BUILDINGS
- NEW SIDEWALK
- EXISTING FIRE LANE
- FIRE HYDRANT - SEE CIVIL DRAWINGS

BUILDING DESIGNATIONS

ADSA

810

FIRE & LIFE SAFETY SITE CONDITIONS SUBMITTAL

Division of the State Architect (DSA) documents referenced within this publication are available on the DSA Form or DSA Publications websites.

To facilitate the Division of the State Architect's (DSA) fire and life safety plan review of project site conditions, DSA requires the design professional to provide the following information at time of project submittal for projects consisting of construction of a new campus, construction of new buildings, additions to existing buildings, and for site alternate design means for fire department emergency vehicle access, and fire suppression water supply. Information associated with compliance items 1 through 7 below is to be provided for all project types indicated above. Information associated with items 4 through 7 is to be completed when an alternate means is utilized. Acknowledgment by the school district and signature from the Local Fire Authority (LFA) is only required when an alternate design means is being requested.

The Project Information and Fire & Life Safety Information sections are to be completed for all projects and stamped onto the fire access site plan. When an alternate design means is proposed, all sections on pages 1 and 2 are to be completed and stamped on the fire access site plan.

For additional information refer to the instructions at the end of this form and DSA Policy PL 09-01: Fire Flow for Buildings.

PROJECT INFORMATION	
School District/Owner:	STOCKTON UNIFIED SCHOOL DISTRICT
Project Name/School:	WEBER INSTITUTE OF APPLIED SCIENCES & TECHNOLOGY
Project Address:	302 W WEBER AVE, STOCKTON, CA 95203

FIRE & LIFE SAFETY INFORMATION	
1. Has a fire hydrant flow test been performed within the past 12 months? (If not, provide a copy of the test data.)	Yes <input checked="" type="checkbox"/> No <input type="checkbox"/>
2. Was the fire hydrant water flow test performed as part of this LFA review?	Yes <input checked="" type="checkbox"/> No <input type="checkbox"/>
3. Is the project located within a designated fire hazard severity zone (FHSZ) as established by Cal-Fire? (If yes, indicate FHSZ classification below.)	Yes <input type="checkbox"/> No <input checked="" type="checkbox"/>
Refer to the following website for FHSZ locations: <a href="https://dnr.ca.gov/fhsz/">https://dnr.ca.gov/fhsz/</a>	Moderate <input type="checkbox"/> High <input type="checkbox"/> Very High <input type="checkbox"/>
Wildland Interface Area (WIFA) (If any designations are checked, project design must meet the requirements of CBC Chapter 2A.)	WIFA <input type="checkbox"/>

CONDITION MEANS AND METHODS RESOLUTION	ALTERNATE ACCEPTED		
4. Emergency vehicle access roadways do not meet CFC requirements.	Yes	No	NA
4a. <b>Acceptable Alternative:</b> Emergency vehicle and personnel access as proposed by the project architect is acceptable for providing the suppression and protection of the life and property.			<input checked="" type="checkbox"/>
5. <b>Fire Hydrants:</b> Number and spacing does not meet CFC requirements.			<input checked="" type="checkbox"/>
5a. <b>Acceptable Alternative:</b> Number of fire hydrants and spacing as proposed by the project architect is acceptable for the suppression and protection of the life and property.			<input checked="" type="checkbox"/>
6. <b>Fire Hydrants:</b> Water flow and pressure are less than CFC minimum.			<input checked="" type="checkbox"/>
6a. <b>Acceptable Alternative:</b> The available flow and pressure is acceptable for providing fire suppression and protection of the life and property.			<input checked="" type="checkbox"/>
7. Location of fire department connection(s) serving the sprinkler systems or standpipe systems does not meet CFC requirements.			<input checked="" type="checkbox"/>
7a. <b>Acceptable Alternative:</b> The location of fire department connection serving the fire sprinkler system and standpipe system is acceptable for providing fire suppression and protection of the life and property.			<input checked="" type="checkbox"/>

School District Acceptance of Acceptable Design Alternative:

By signing this form, the school district acknowledges and accepts the proposed design as an alternative to California Building Code (CBC) and California Fire Code (CFC) minimum requirements, as indicated by one or more of the conditions indicated at items 4a, 5a, 6a or 7a, for providing fire and life safety protection of the life and property.

Accepted by: \_\_\_\_\_ Title: \_\_\_\_\_

Signature: \_\_\_\_\_ Date: \_\_\_\_\_

LOCAL FIRE AUTHORITY (LFA) INFORMATION

LFA Agency Name: \_\_\_\_\_

LFA Review Official: \_\_\_\_\_

Title: \_\_\_\_\_ Work Phone: \_\_\_\_\_

Work Email: \_\_\_\_\_

LFA Reviewer's Signature: \_\_\_\_\_ Date: \_\_\_\_\_



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3271-016-000  
2101 CAPITOL AVENUE, SUITE 100,  
SACRAMENTO, CA 95816  
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**ISSUE**

NOT FOR CONSTRUCTION

DESCRIPTION	DATE
-------------	------

KEYNOTES

NOTES

FACILITY:  
WEBER INSTITUTE OF APPLIED SCIENCES & TECHNOLOGY  
302 W WEBER AVE,  
STOCKTON, CA 95203

PROJECT:  
STOCKTON USD WEBER INSTITUTE GYMNASIUM

SHEET NAME:  
LOCAL FIRE AUTHORITY SITE ACCESS PLAN

DESIGN DEVELOPMENT


DATE: 04/16/2025  
CLIENT PROJ NO:

SHEET:

LOCAL FIRE AUTHORITY ACCESS SITE PLAN

1

1" = 30'-0"

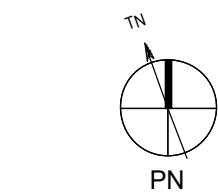

PLEASE RECYCLE


G1.31



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VAN BUREN STREET

WEBER AVENUE

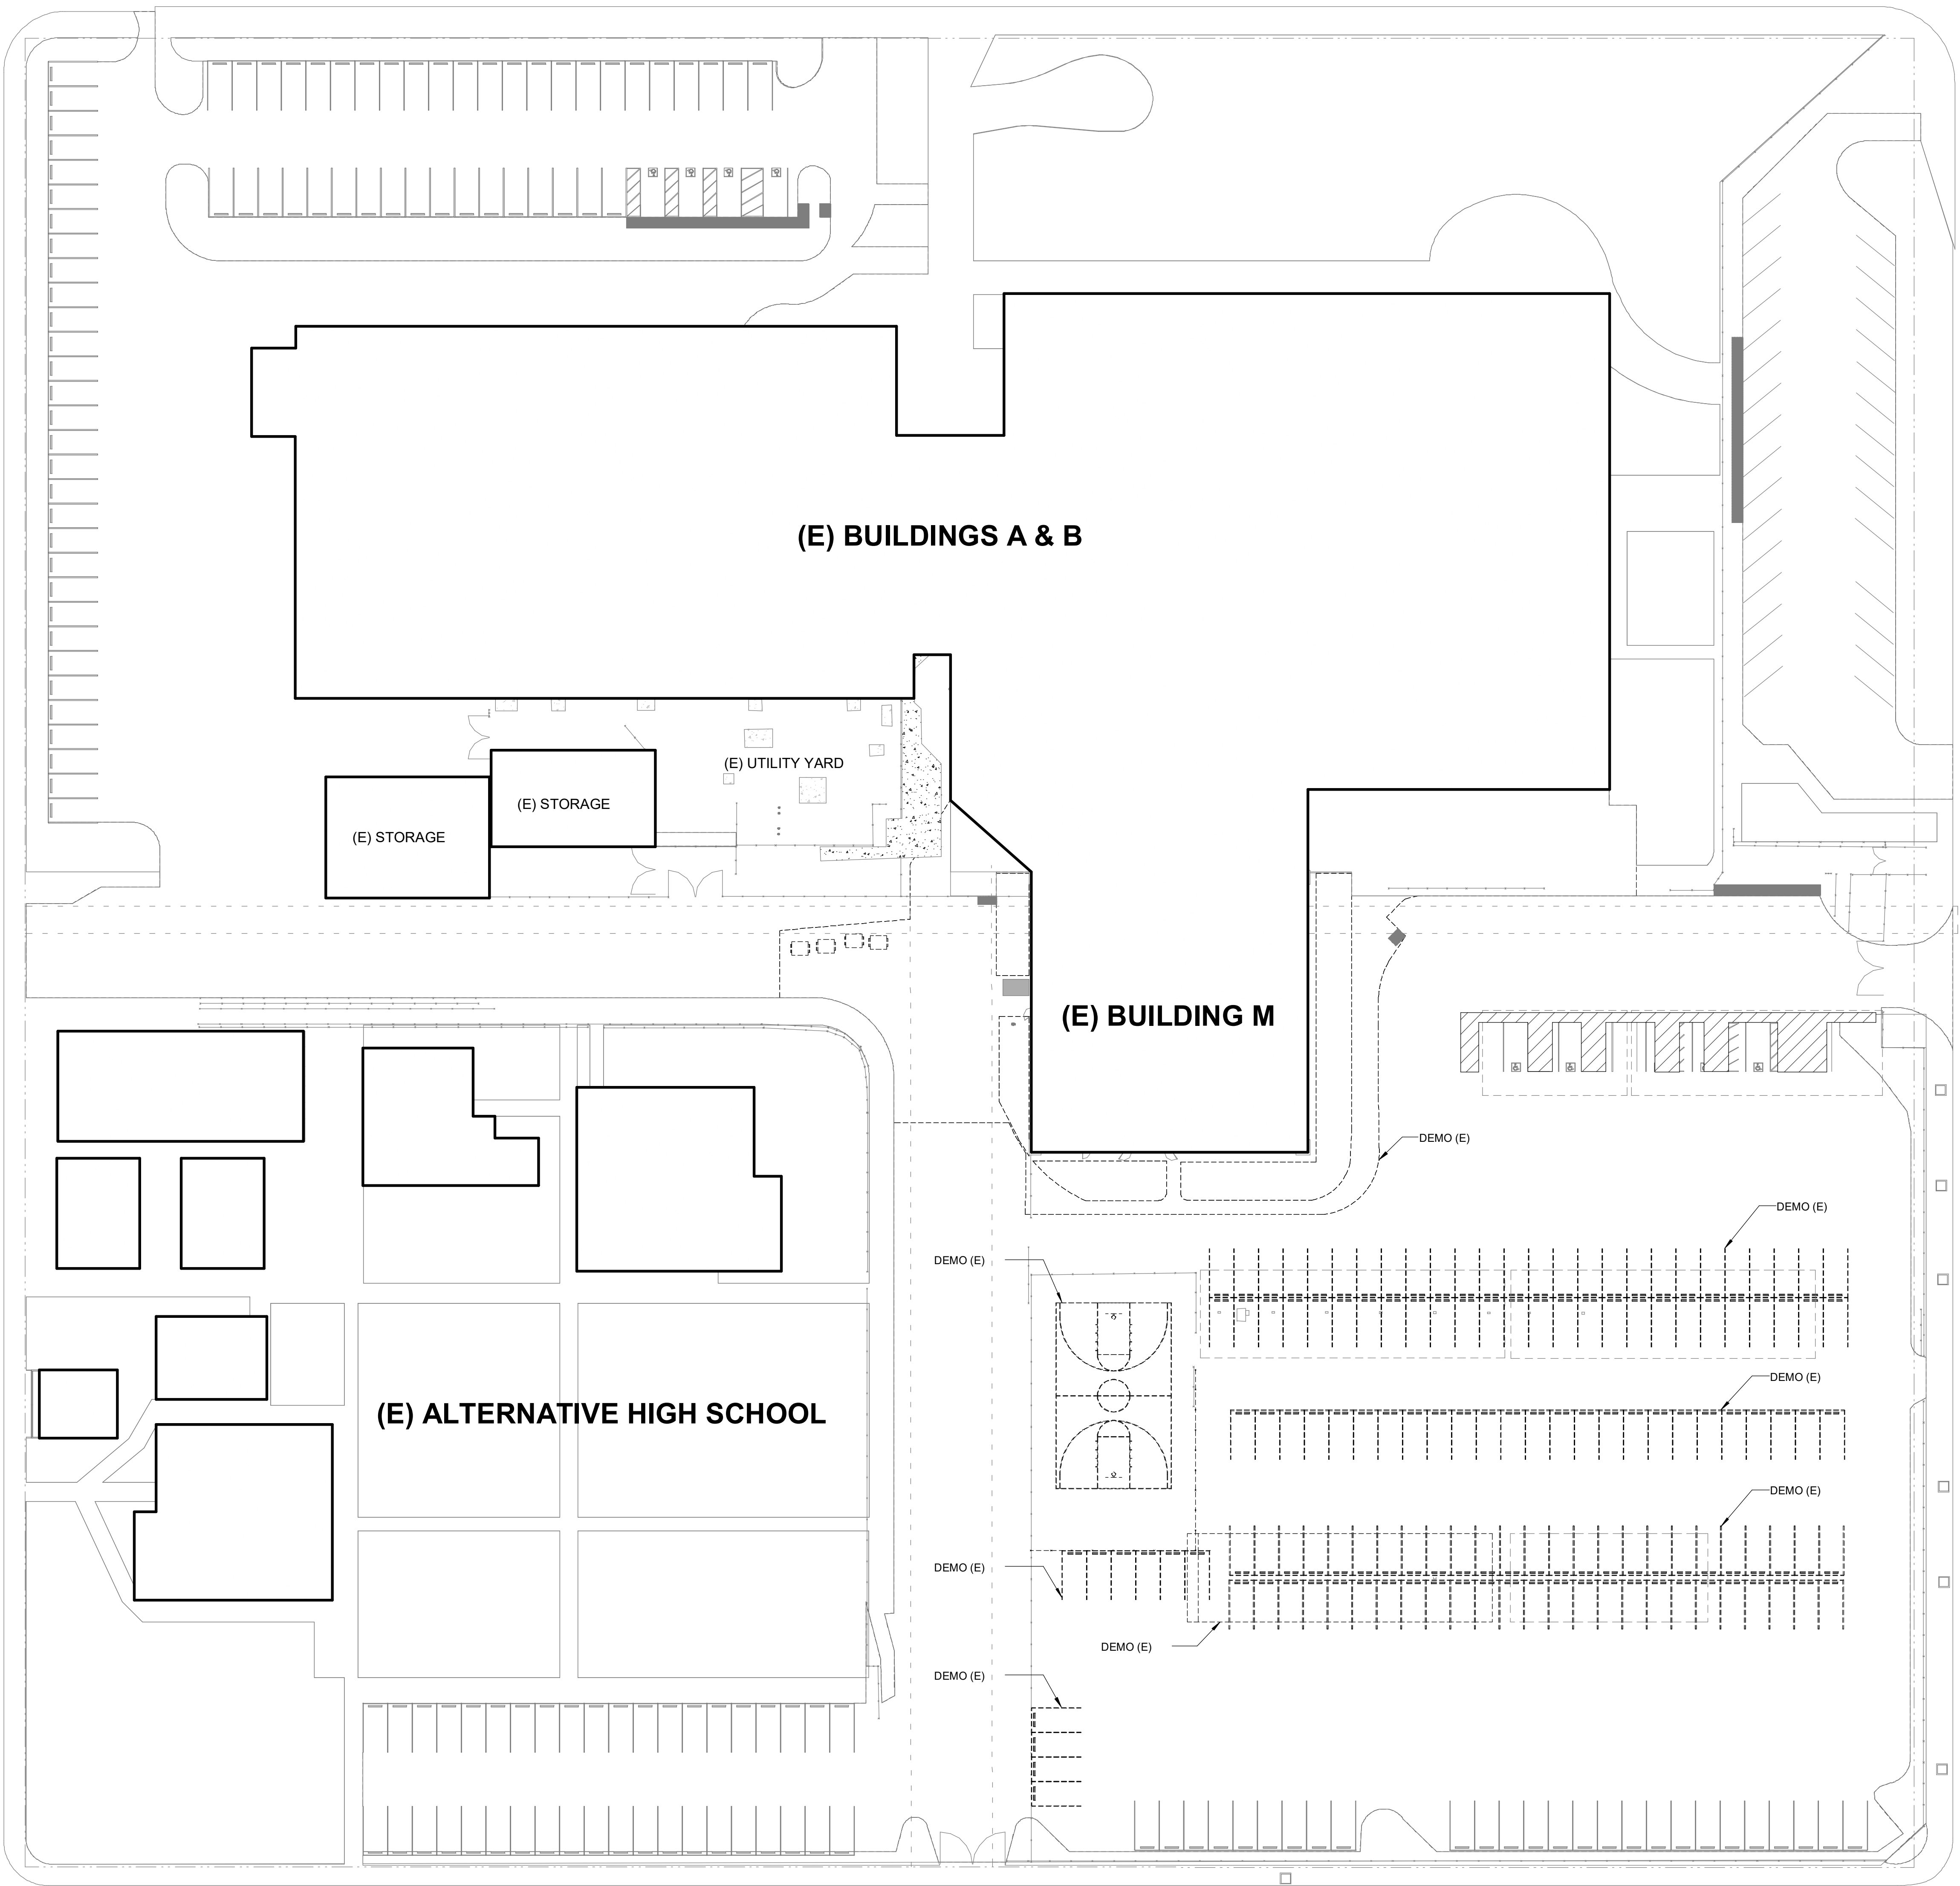


MARKET STREET

MADISON STREET

LEGEND

- APPROXIMATE LIMIT OF WORK. REFER TO ADDITIONAL DRAWINGS FOR WORK WHICH MAY EXTEND BEYOND THIS APPROXIMATE LIMIT OF WORK LINE.
- PROPERTY LINE
- EASEMENT LINE
- PATH OF TRAVEL
- EGRESS PATH
- CHAIN LINK FENCE
- NEW BUILDING
- EXISTING BUILDINGS
- ASPHALT CONCRETE PAVING
- CONCRETE WALK
- LANDSCAPE AREA
- FIRE HYDRANT - SEE CIVIL DRAWINGS

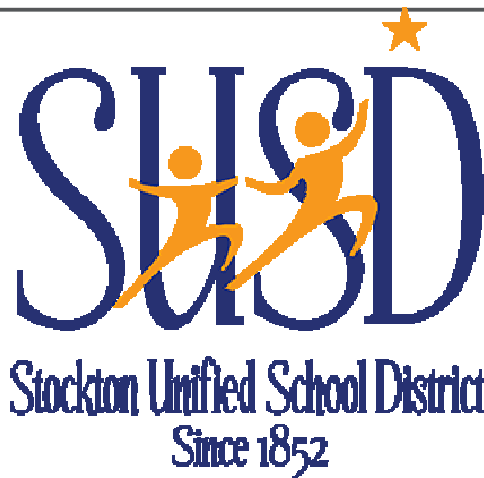

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**ISSUE**

DESCRIPTION	DATE
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KEYNOTES

NOTES

- REFER TO SHEET G0.11 FOR TYPICAL SYMBOLS AND ABBREVIATIONS
- REFER TO LANDSCAPE DRAWINGS FOR PAVING AND PLANTING INFORMATION
- REFER TO MECHANICAL, ELECTRICAL, AND PLUMBING DRAWINGS FOR UTILITY INFORMATION
- CONTRACTOR IS RESPONSIBLE FOR REPAIR/REPLACEMENT OF ALL HARDSCAPE/PLANTING OUTSIDE OF LIMIT OF WORK LINE FOR CONNECTION OF UNDERGROUND UTILITIES

FACILITY:  
**WEBER INSTITUTE OF APPLIED SCIENCES & TECHNOLOGY**  
302 W WEBER AVE,  
STOCKTON, CA 95203

PROJECT:  
**STOCKTON USD WEBER INSTITUTE GYMNASIUM**

SHEET NAME:  
**SITE DEMOLITION PLAN**

**DESIGN DEVELOPMENT**


DATE: 4/15/2025  
CLIENT PROJ NO:

SHEET:

SITE DEMOLITION PLAN

1


1" = 30'-0"

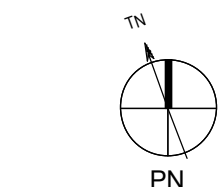

PLEASE RECYCLE

A1.01

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STOCKTON, CA 95203

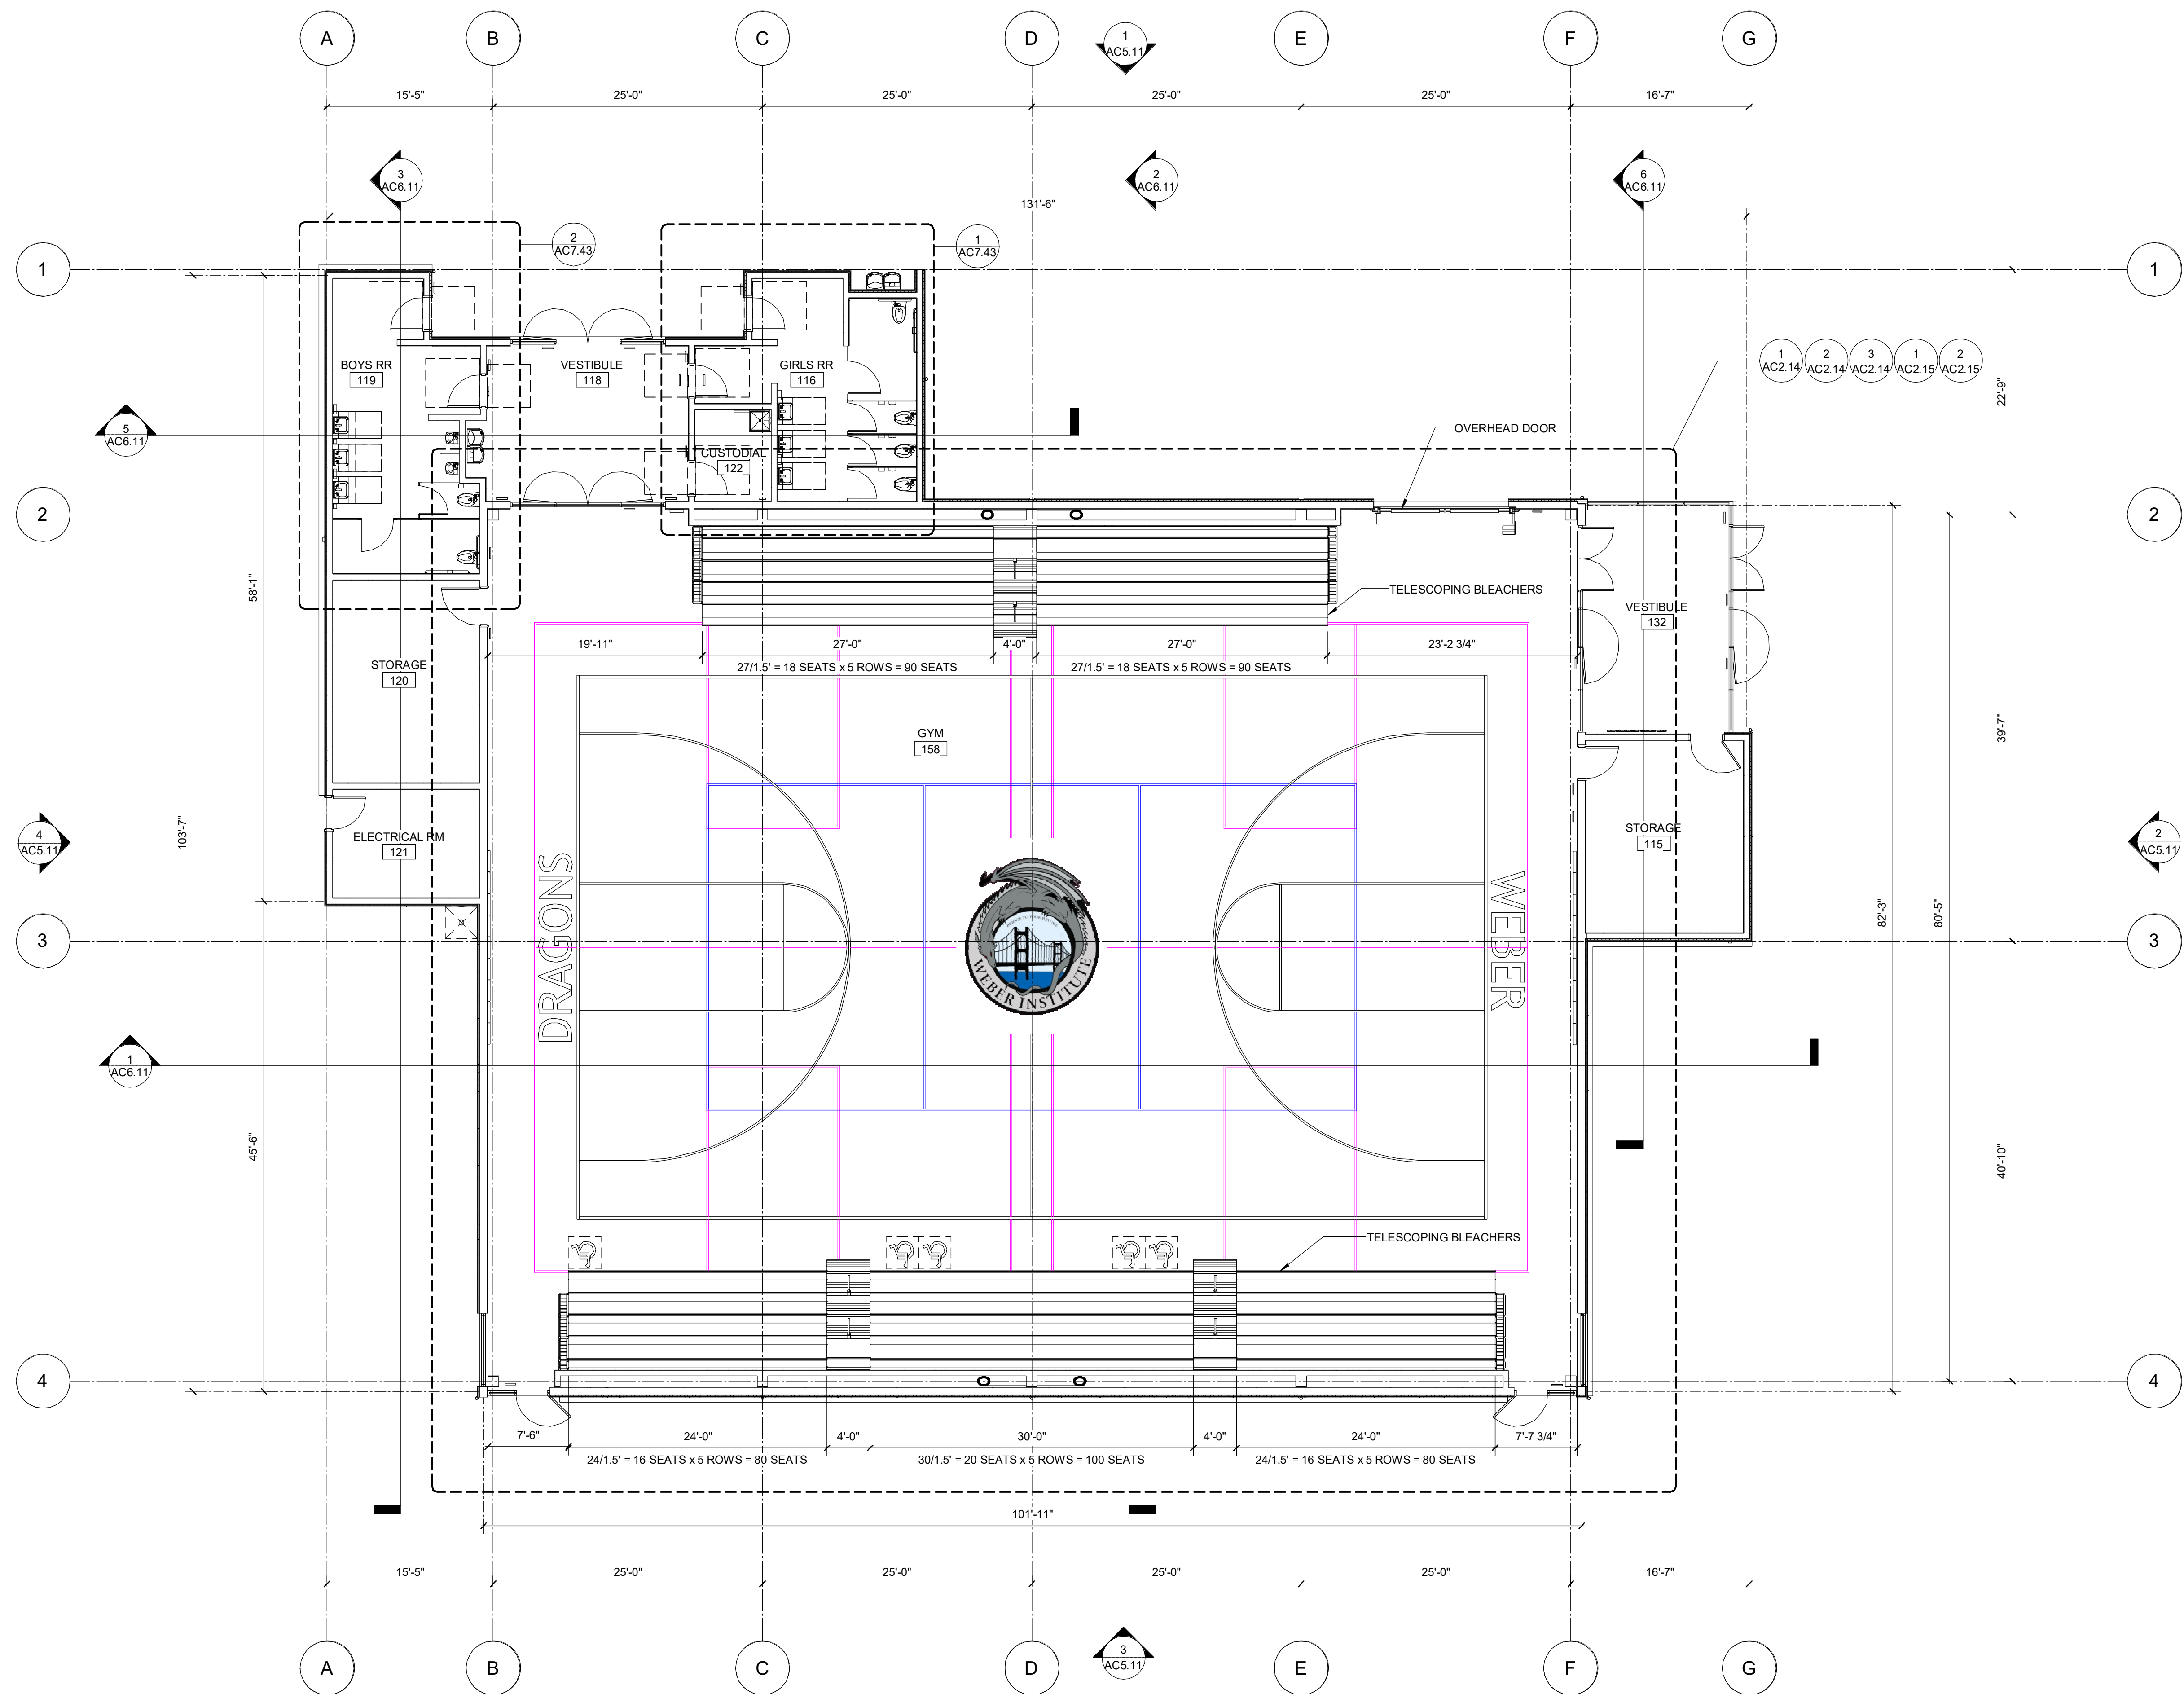PROJECT:  
**STOCKTON USD WEBER INSTITUTE GYMNASIUM**


SHEET NAME:  
**BUILDING C - FLOOR PLAN**

**DESIGN DEVELOPMENT**

DATE: 4/15/2025  
CLIENT PROJ NO:

SHEET:

**BUILDING C - FLOOR PLAN**  
**1**  
1/8" = 1'-0"

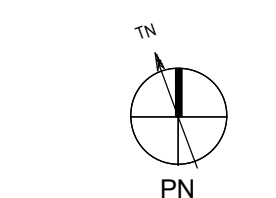


PLEASE RECYCLE

**AC2.11**




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LEGEND

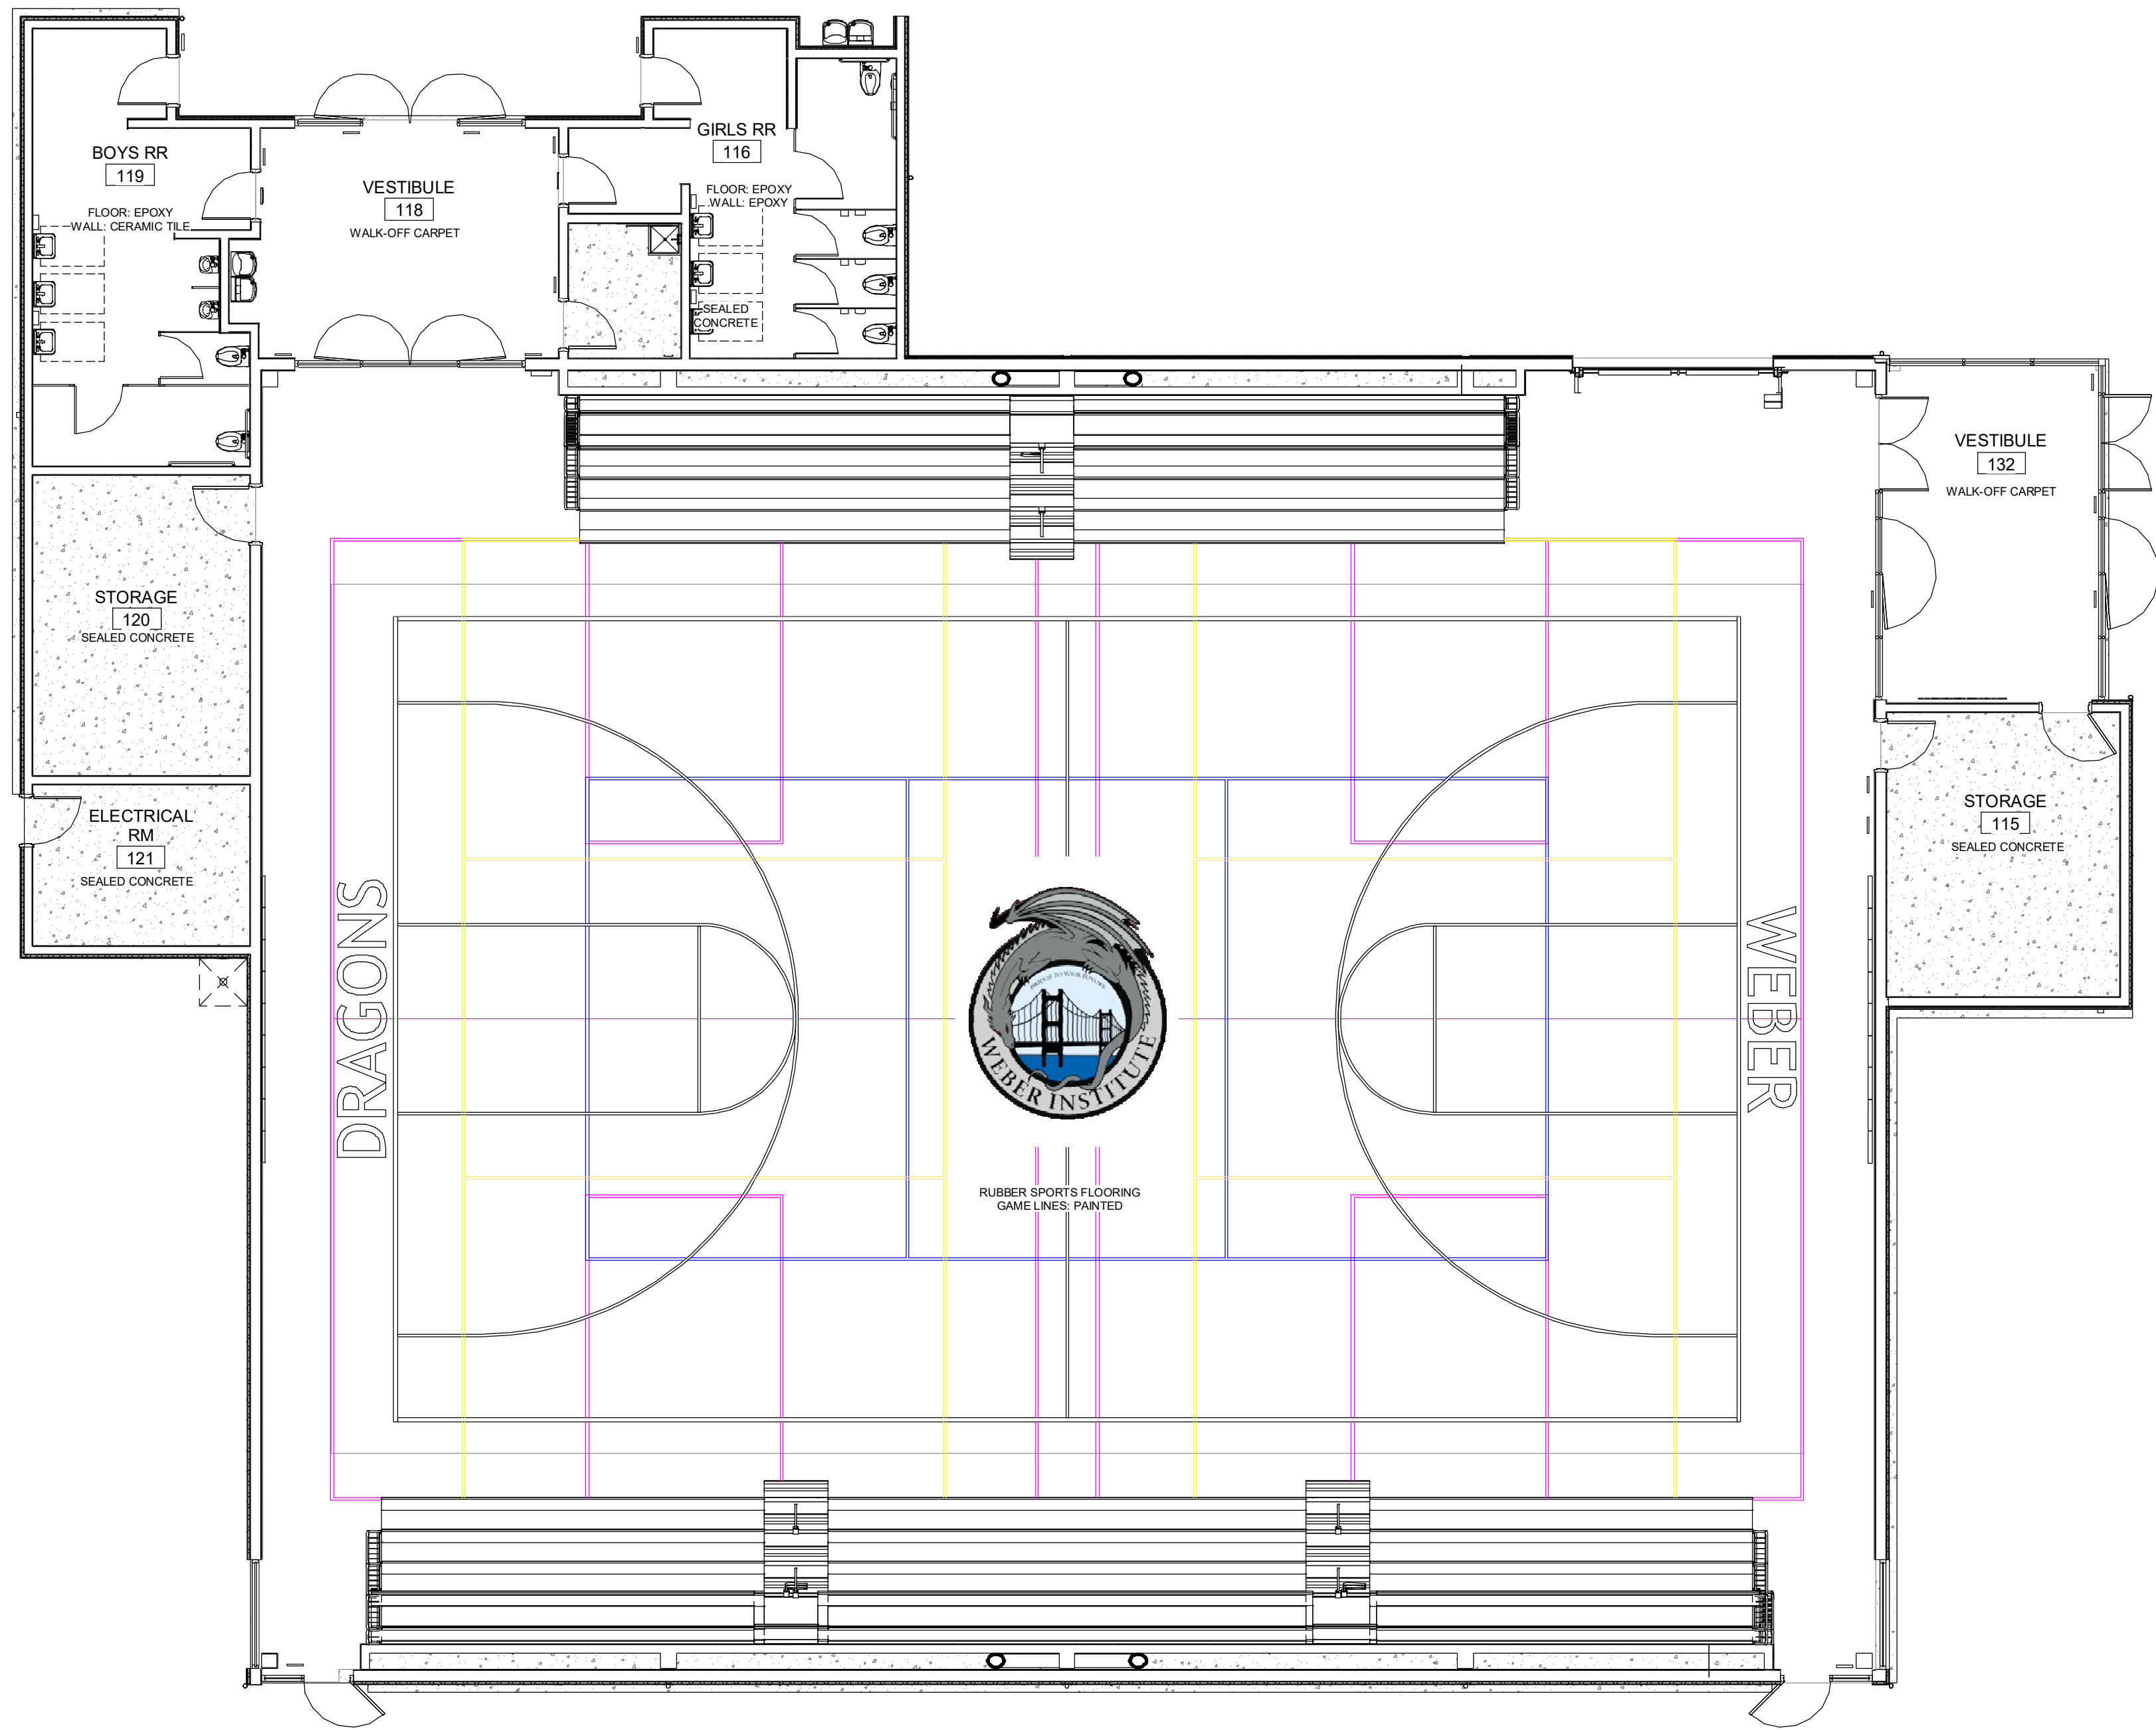- Room Name  
### ROOM FIELD WALL FINISH - SEE SCHEDULE  
\* = MULTIPLE FINISHES, SEE INT ELEVATION  
XX# WALL BASE FINISH, SEE FINISH SCHEDULE  
XX# ROOM FLOORING FINISH, SEE FINISH SCHEDULE
- FINISHES NOTED ABOVE ARE TYPICAL FIELD FINISHES FOR THE ROOM, U.N.O. ADDITIONAL FINISHES MAYH BE INDICATED ON THIS PLAN AND/OR INTERIOR ELEVATIONS.
- FA FINISH/COLOR - SEE FINISH SCHEDULE
- ↗ DENOTES DIRECTION OF FLOORING - IF APPLICABLE



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**ISSUE**

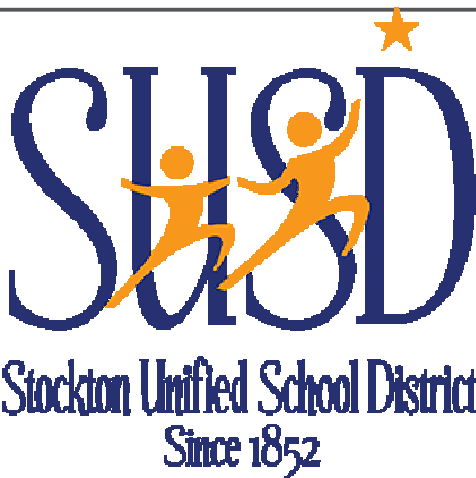DESCRIPTION	DATE
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KEYNOTES

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FACILITY:  
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302 W WEBER AVE,  
STOCKTON, CA 95203

PROJECT:  
**STOCKTON USD WEBER INSTITUTE GYMNASIUM**

SHEET NAME:  
**BUILDING C - FINISH & SIGNAGE PLAN**


**DESIGN DEVELOPMENT**

DATE: 4/15/2025  
CLIENT PROJ NO:

SHEET:

BUILDING C - FINISH & SIGNAGE PLAN

**A1**  
1/8" = 1'-0"

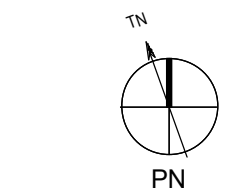


PLEASE RECYCLE ♻️


**AC2.13**



**2**  
 $1/8'' = 1'-0''$

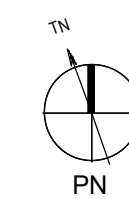

**3**  
 $1/8'' = 1'$

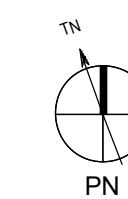


**1**  
1/8" = 1'-0"




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ALL DIMENSIONS AND NOTES ARE IN FEET AND INCHES UNLESS OTHERWISE NOTED. SHEET ORIGINAL PAGE SIZE

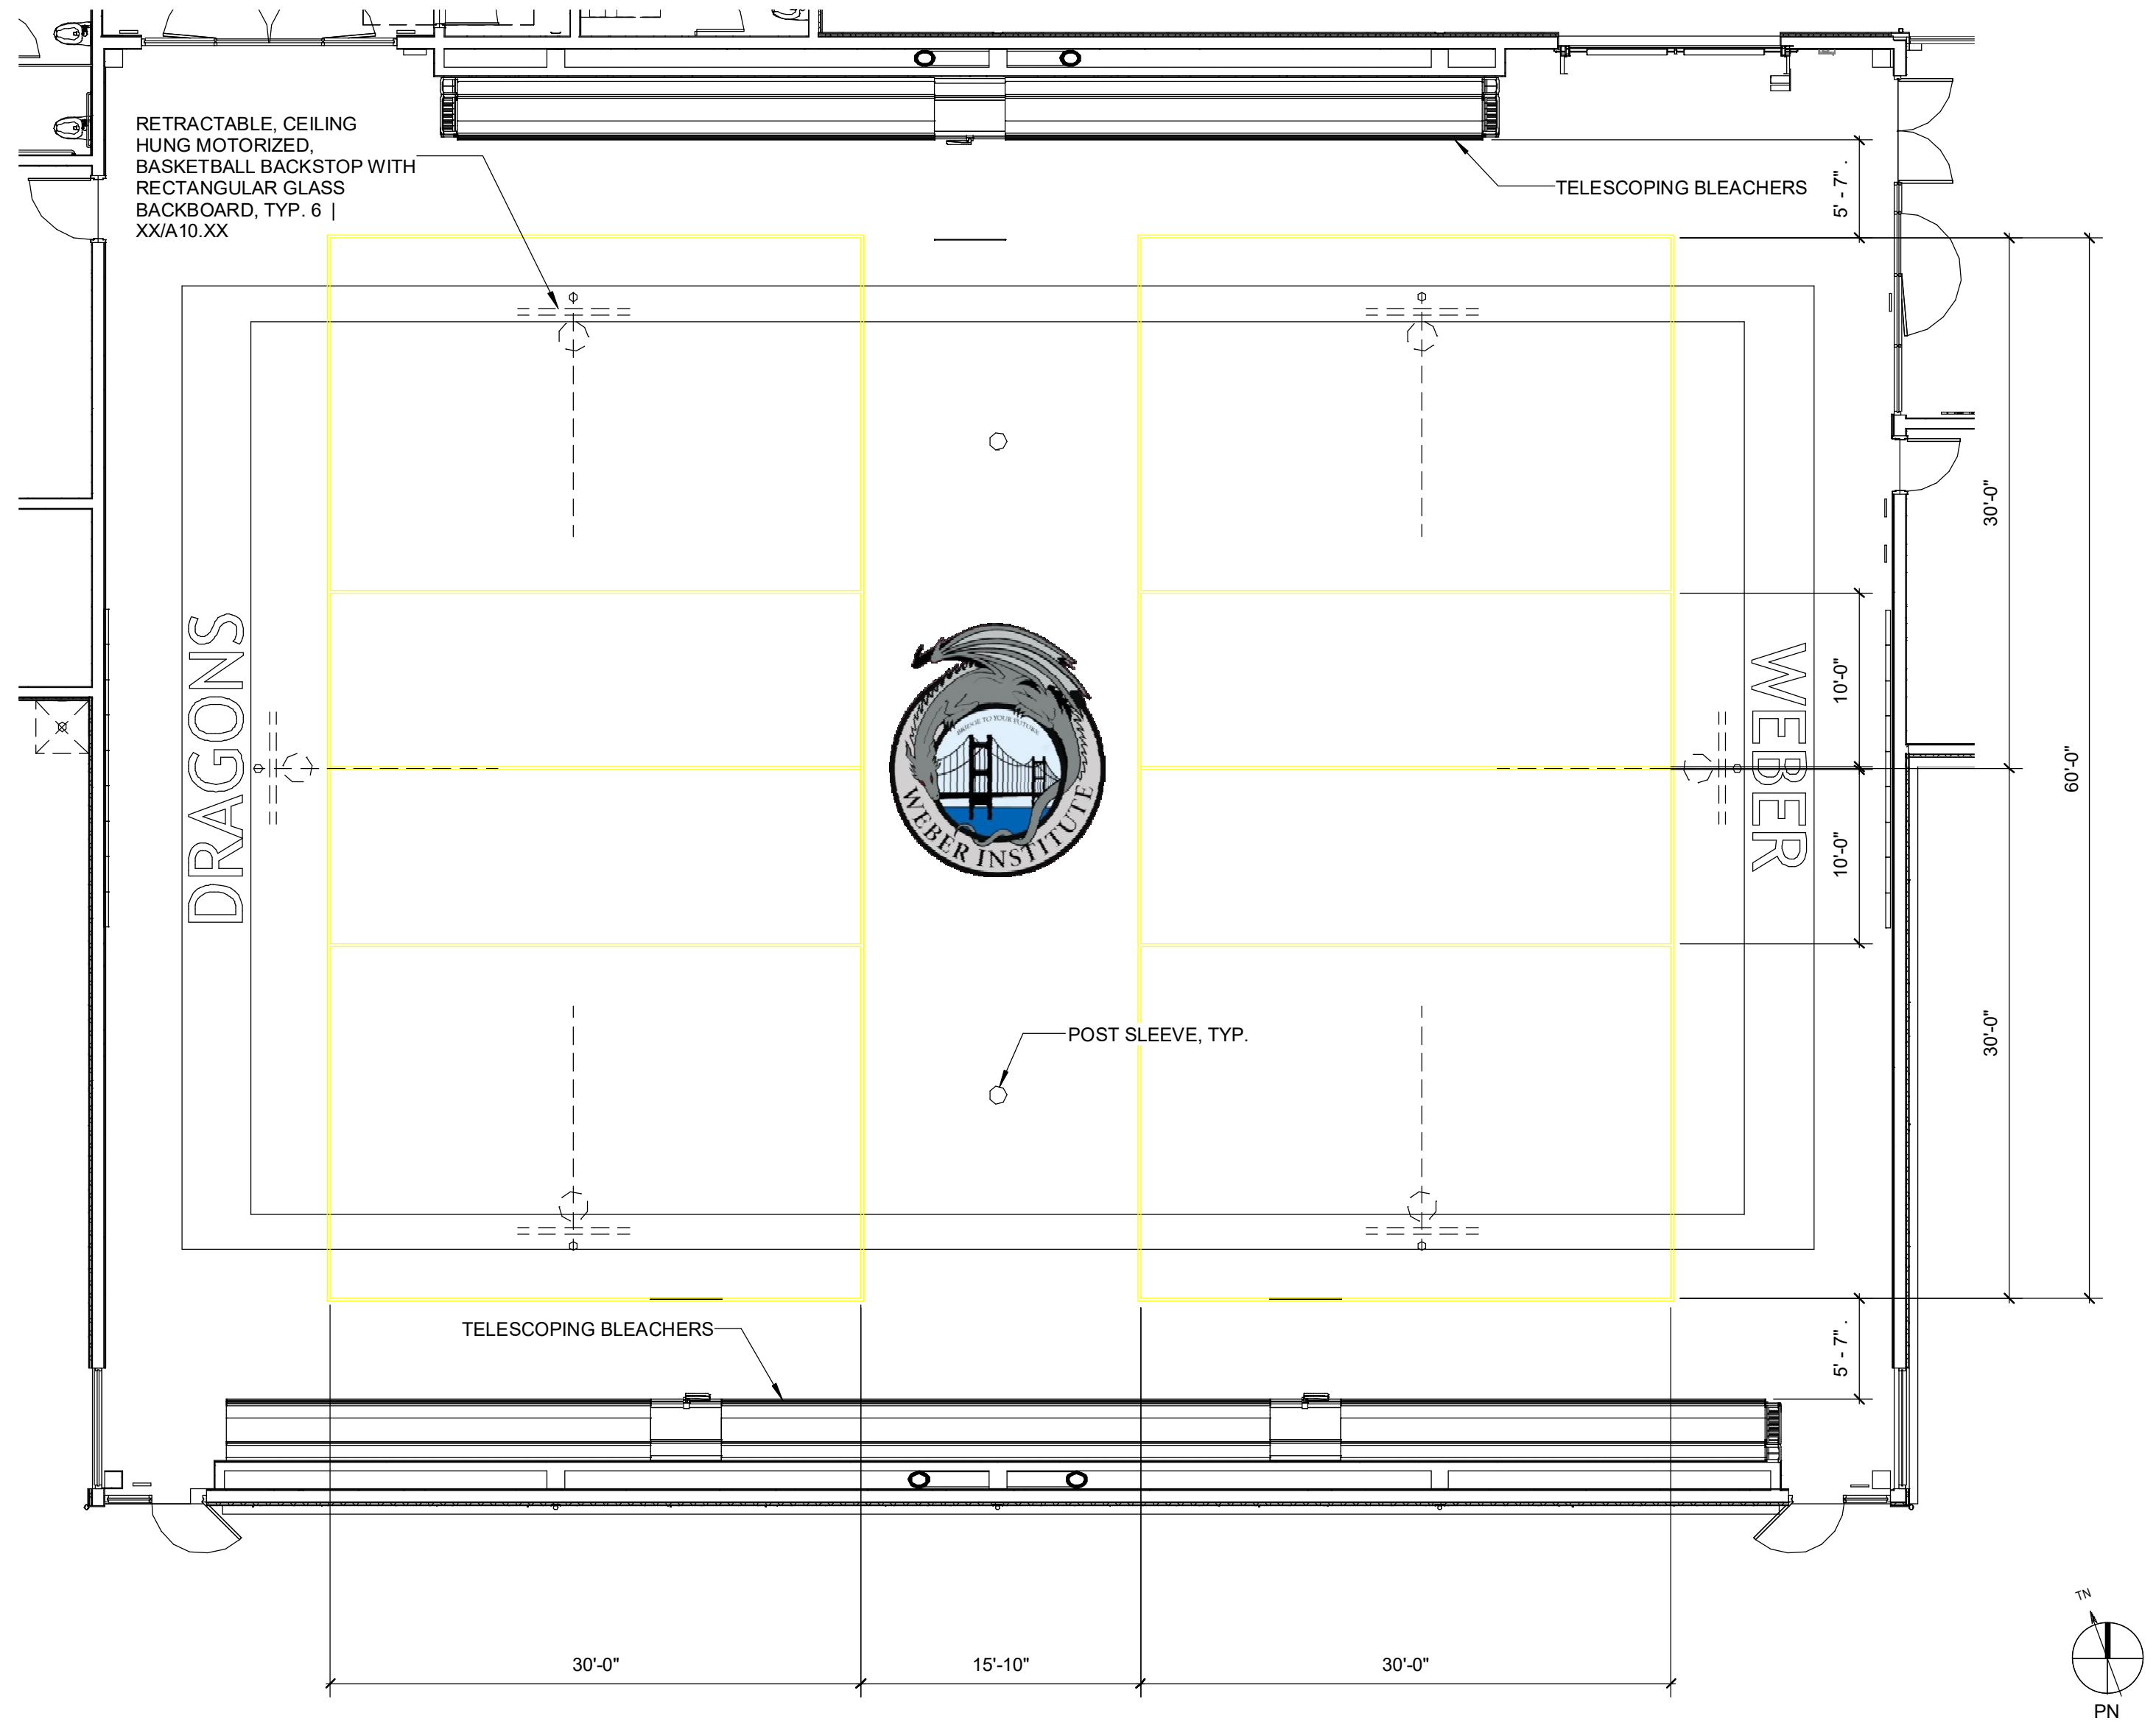

ENLARGED VIEW - PRACTICE VOLLEYBALL COURT PLAN 2  
1/8" = 1'-0"

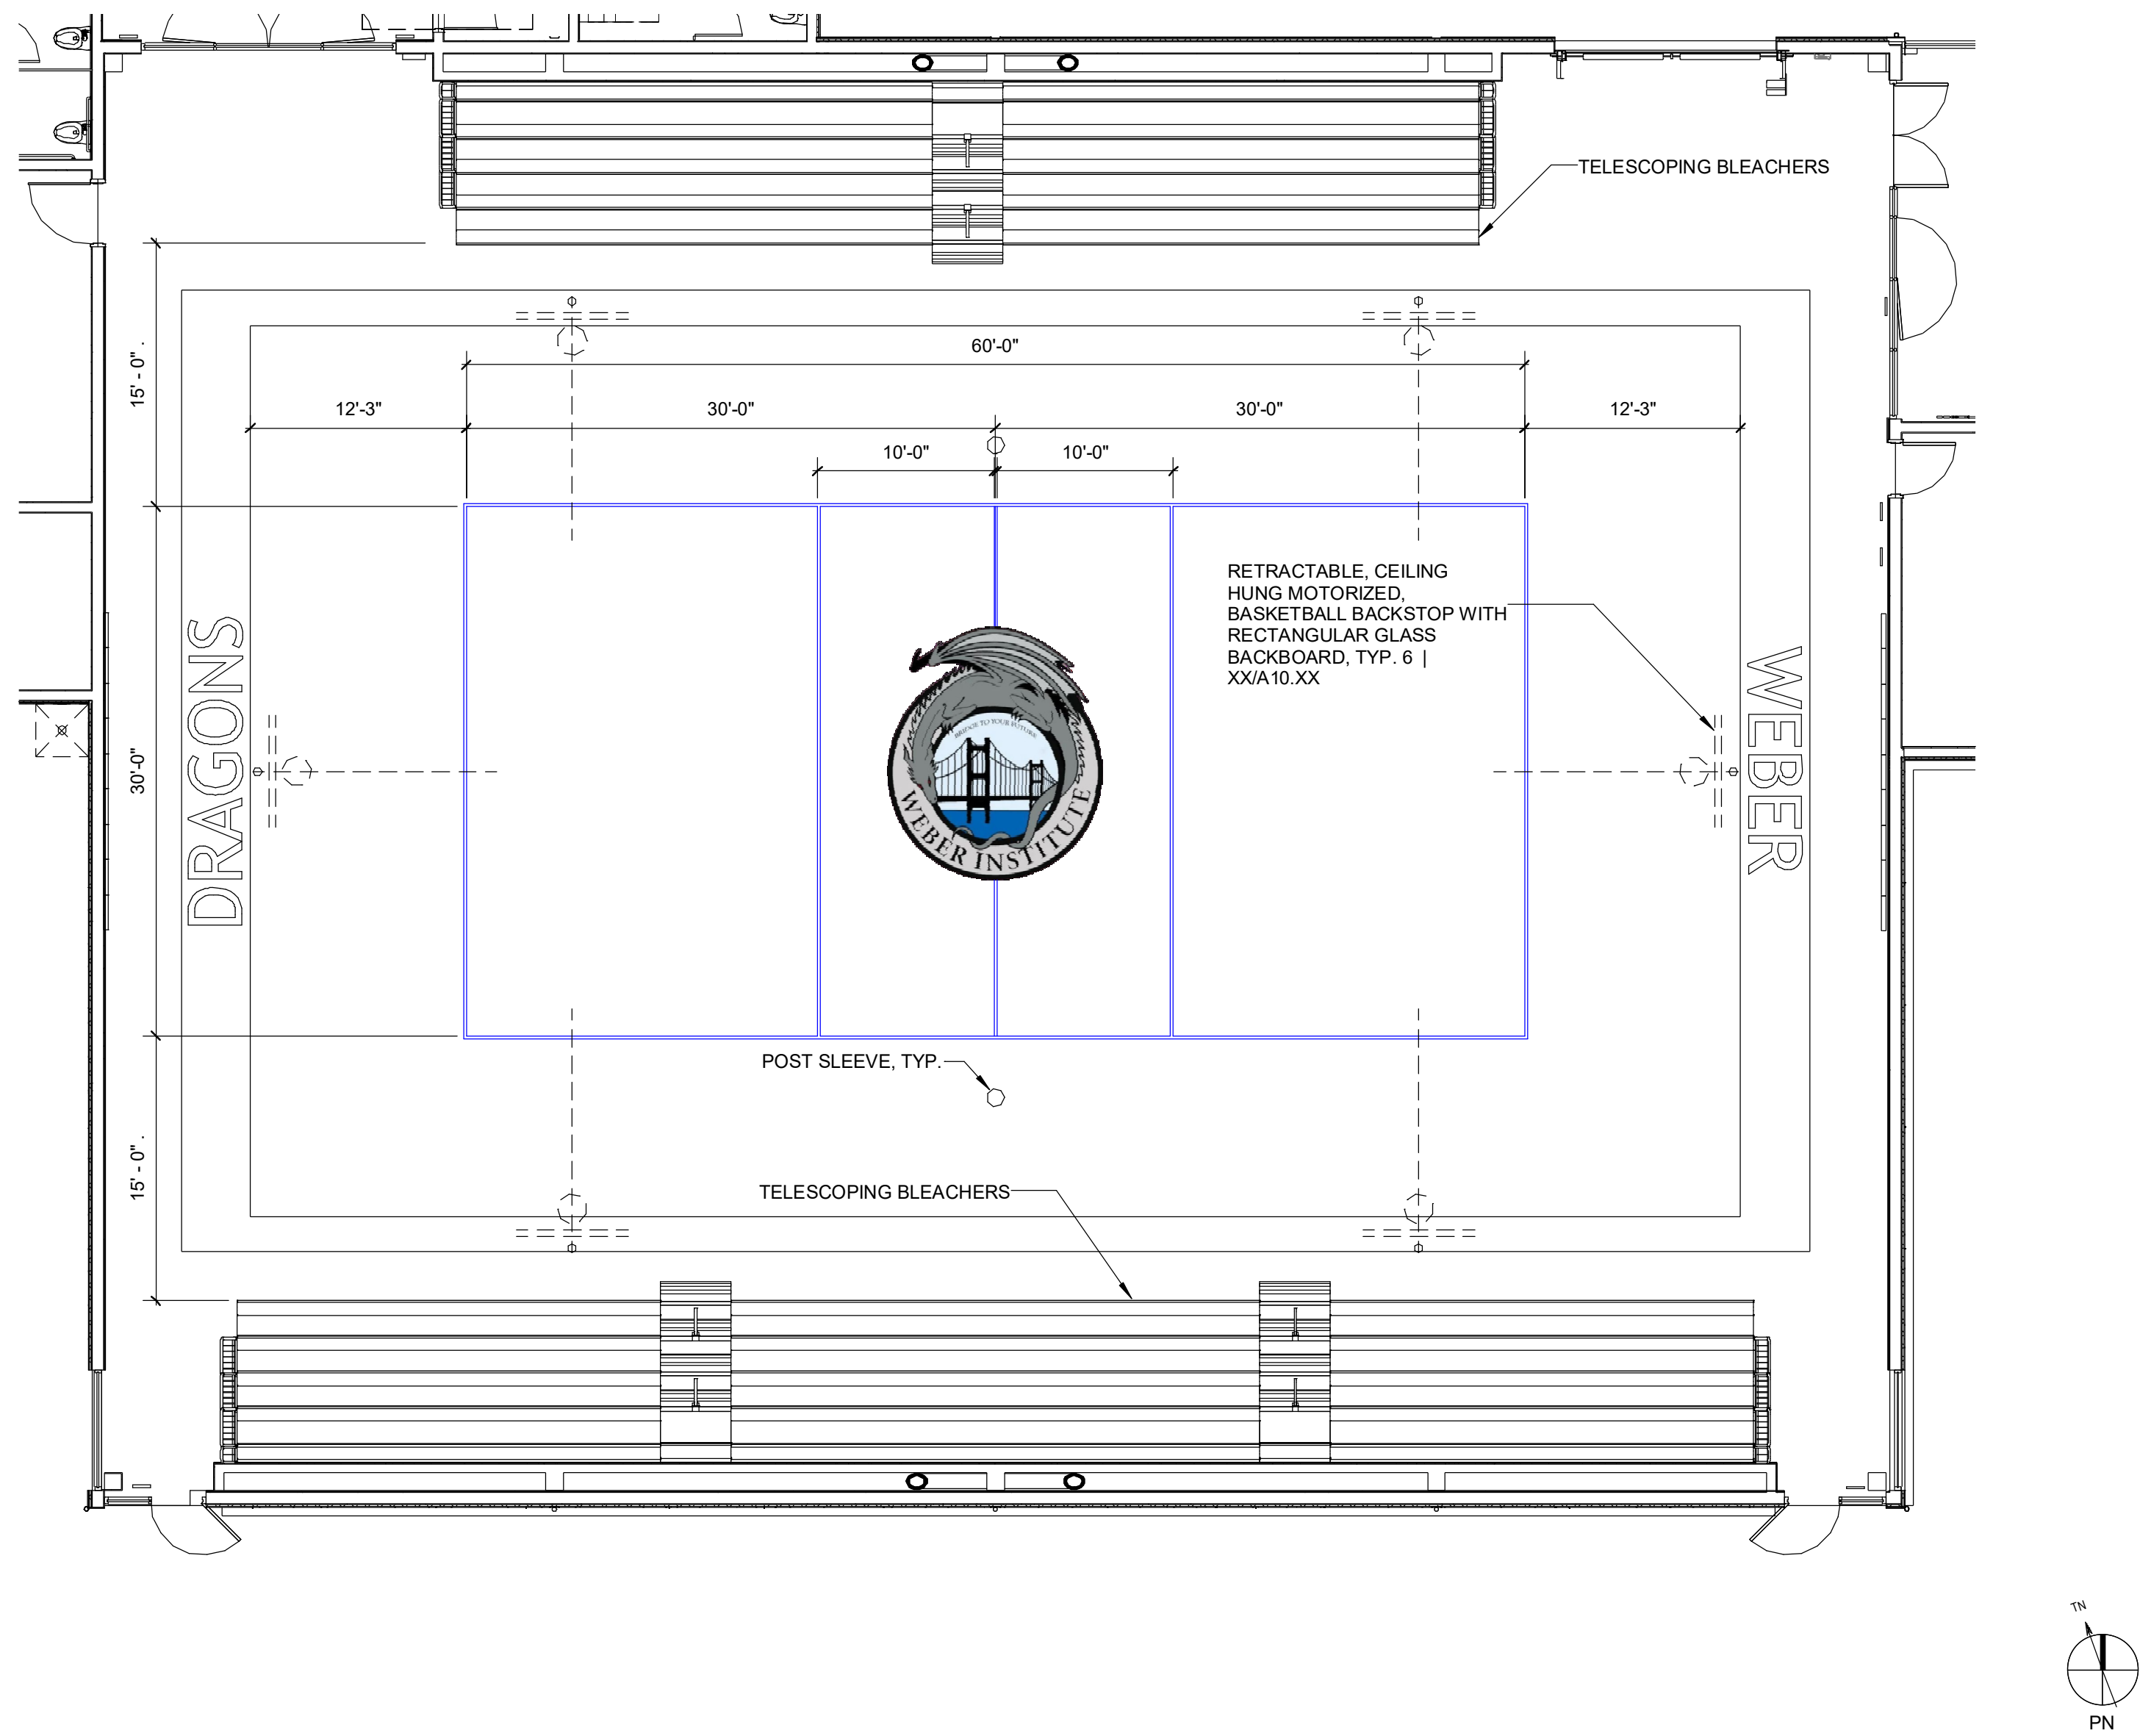

ENLARGED VIEW - MAIN VOLLEYBALL COURT PLAN 1  
1/8" = 1'-0"



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DESCRIPTION	DATE

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COURT DIAGRAM	COLOR
MAIN BASKETBALL COURT	GREEN
PRACTICE BASKETBALL COURT	PINK
MAIN VOLLEYBALL COURT	BLUE
PRACTICE VOLLEYBALL COURT	YELLOW

FACILITY:  
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STOCKTON, CA 95203

PROJECT:  
**STOCKTON USD WEBER INSTITUTE GYMNASIUM**

SHEET NAME:  
**BUILDING C - COURT STRIPING PLAN**

**DESIGN DEVELOPMENT**

DATE: 4/15/2025  
CLIENT PROJ NO:

SHEET:

AC2.15

PLEASE RECYCLE




## BUILDING ELEMENTS

- 
- GB, PLASTER, OR STUCCO CEILING- REF: CEILING TAGS
- 24"x24" ACOUSTIC TILE CEILING SYSTEM- REF: CEILING TAGS AND SPECIFICATIONS
- 24"x48" ACOUSTIC TILE CEILING SYSTEM- REF: CEILING TAGS AND SPECIFICATIONS
- 24"x48" DIRECT ATTACH WOOD FIBER ACOUSTIC PANEL- REF: CEILING TAGS AND SPECIFICATIONS



1. DIMENSIONS TO FACE OF PARTITIONS ARE TO FACE OF SUBSTRATE LAYER AS SHOWN IN PARTITION TYPES ON A0.11. FINISHES DEPICTED IN FINISH PLANS AND ELEVATIONS ARE NOT SHOWN ON PARTIAL FLOOR PLANS. REFER TO ENLARGED PLANS, ELEVATIONS, AND DETAILS.

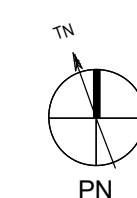

**1**  
1/8" = 1'-4"

PLEASE RECYCLE 



## NOTES

## DESIGN DEVELOPMENT


DATE: 4/15/2025	CLIENT PROJ NO:
SHEET:	

## AC3.11




AutoCAD Docs:\3271016000 Stockton USD Weber Institute Gymnasium\3271016000-A-WEBER-INST-SITE.rvt 4/17/2025 7:30:19 AM

ALL DIMENSIONS AND NOTES  
SHOWN ON THIS SHEET  
ARE IN FEET AND INCHES  
UNLESS OTHERWISE NOTED  
SHEET ORIGINAL PAGE SIZE

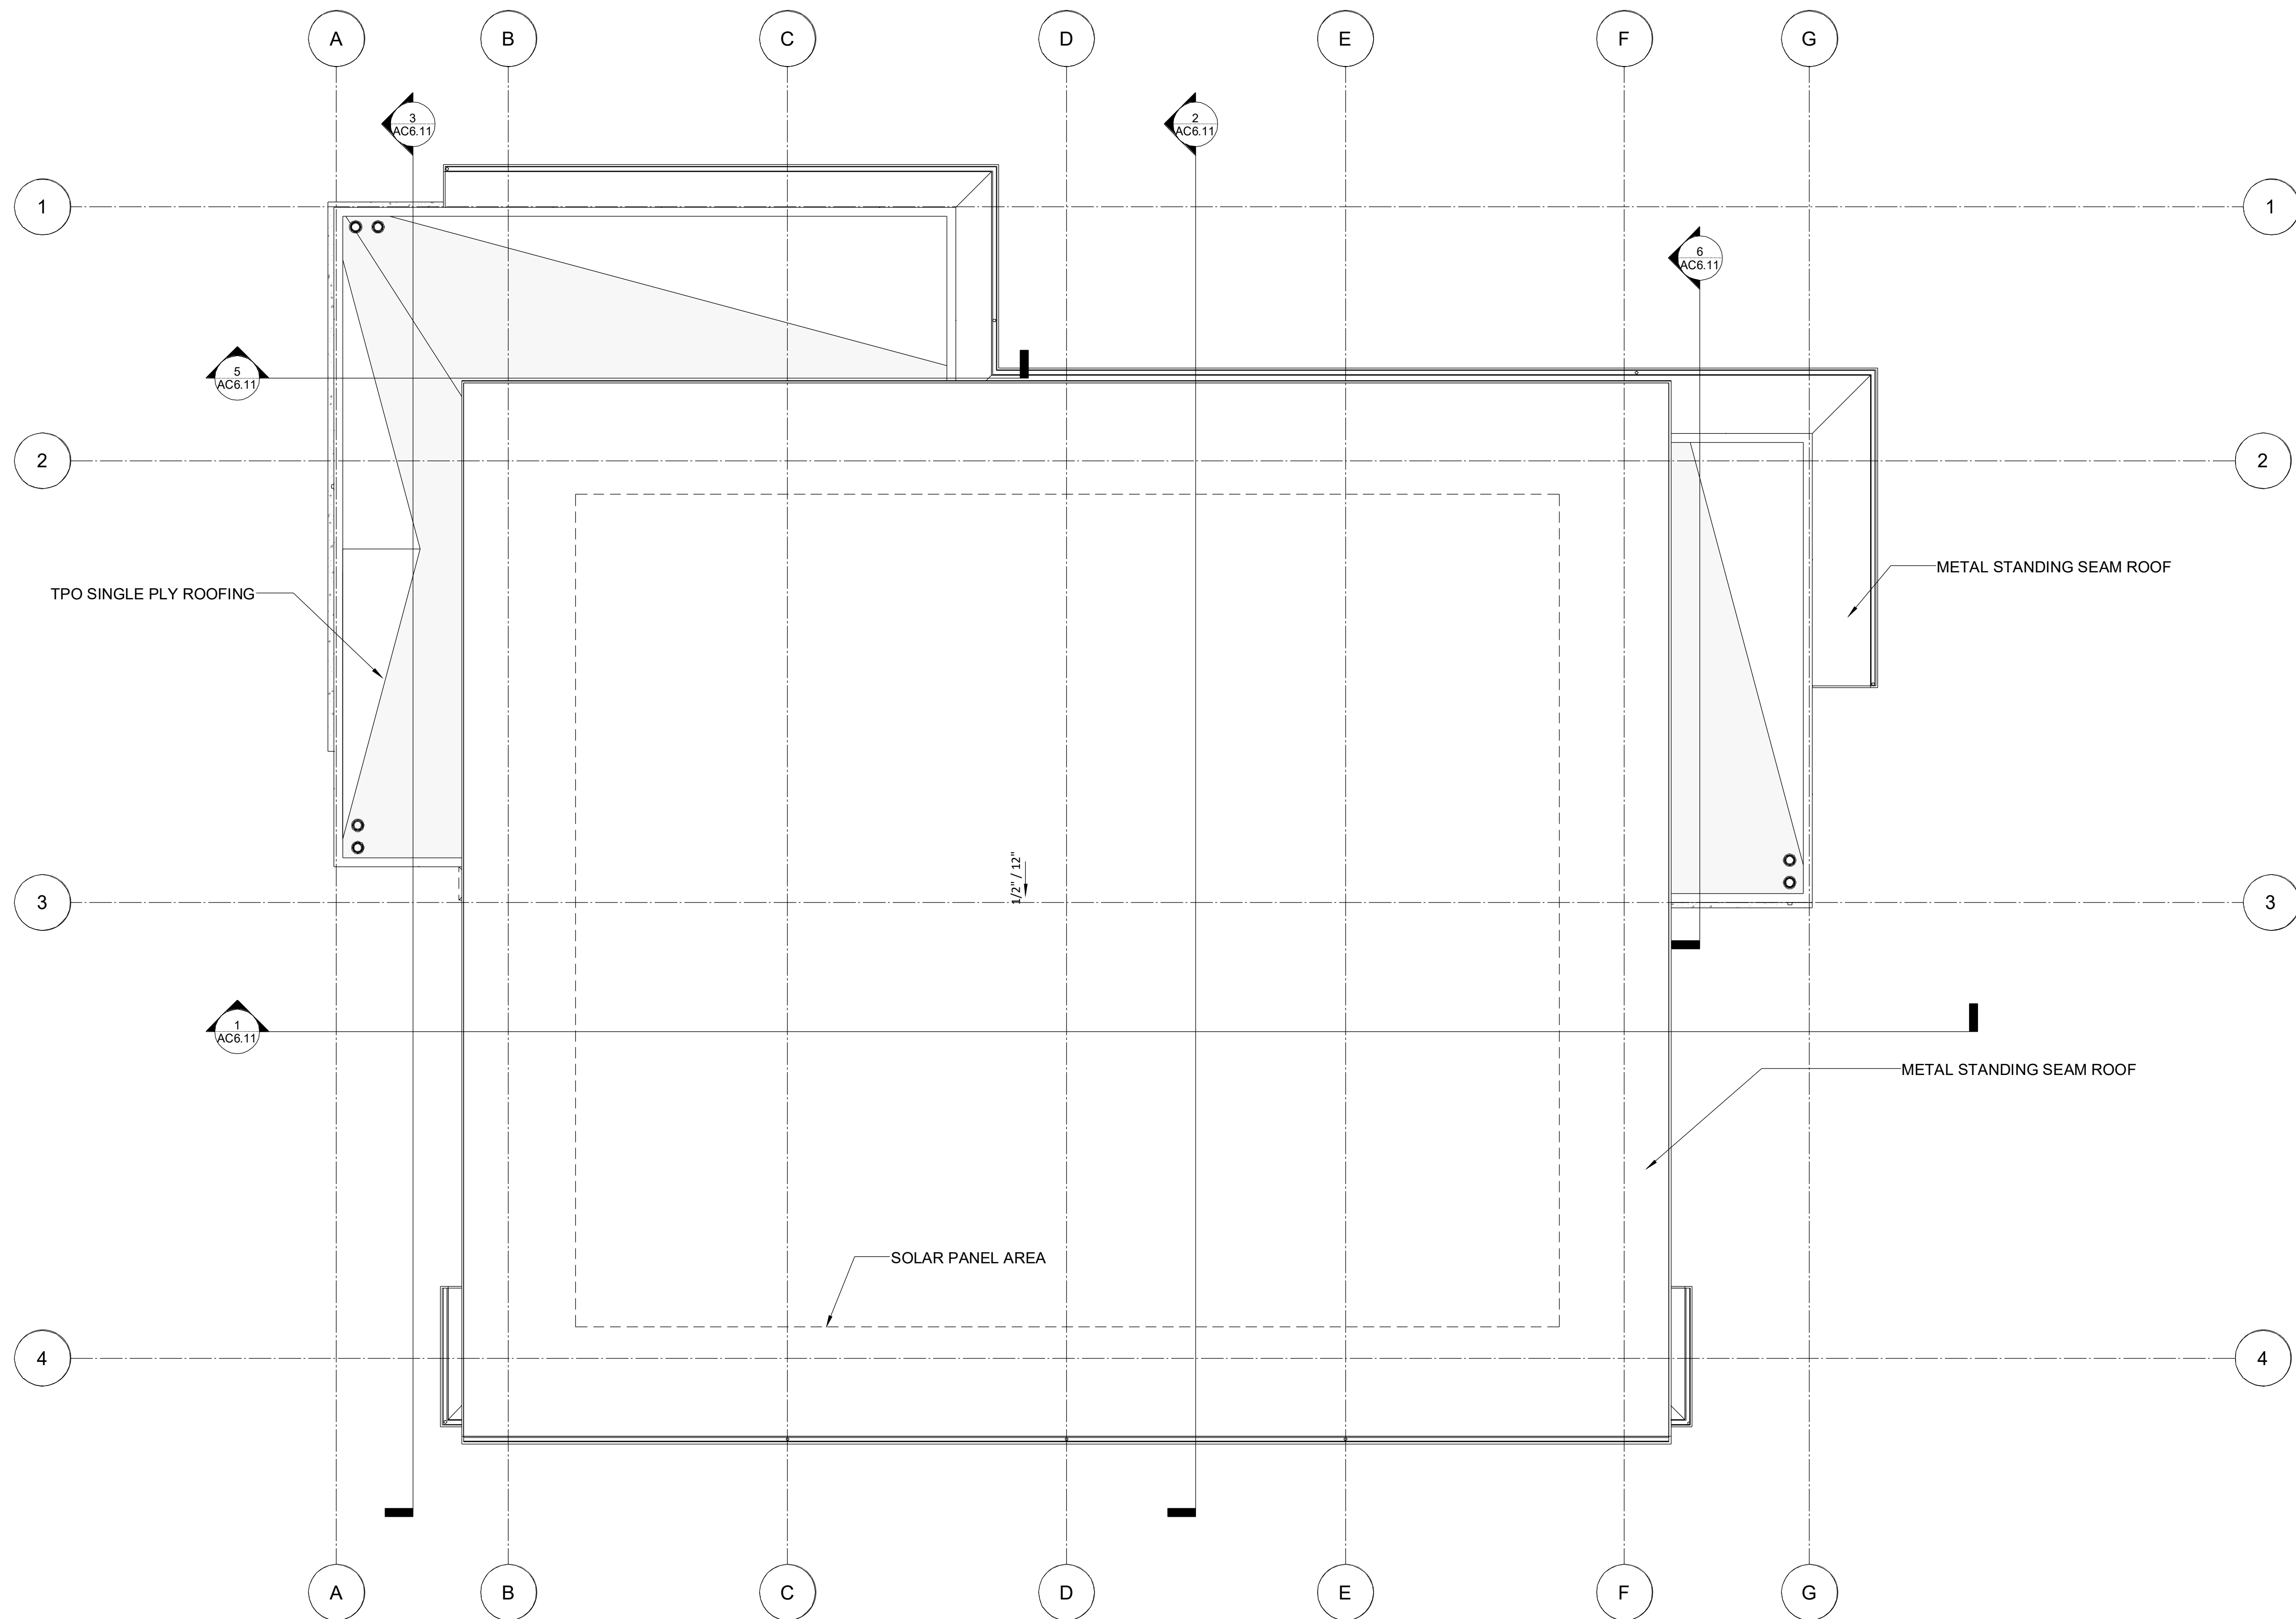

BUILDING C - ROOF PLAN 1  
1/8" = 1'-0"

PLEASE RECYCLE ♻️

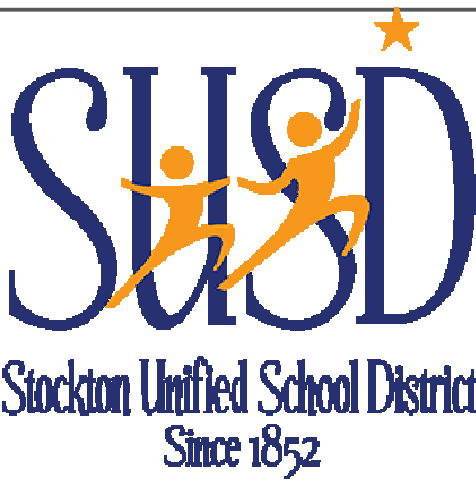

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FOR  
GOOD

HMC  
Architects

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ISSUE

DESCRIPTION	DATE
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#### KEYNOTES

#### NOTES

FACILITY:  
WEBER INSTITUTE OF APPLIED SCIENCES & TECHNOLOGY  
302 W WEBER AVE,  
STOCKTON, CA 95203

PROJECT:  
STOCKTON USD WEBER INSTITUTE GYMNASIUM

SHEET NAME:  
BUILDING C - ROOF PLAN

DESIGN DEVELOPMENT


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SHEET:	

AC4.11



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THE LINE SHOWN ABOVE THE FACILITY IS NOT TO SCALE. SHEET ORIGINAL PAGE SIZE

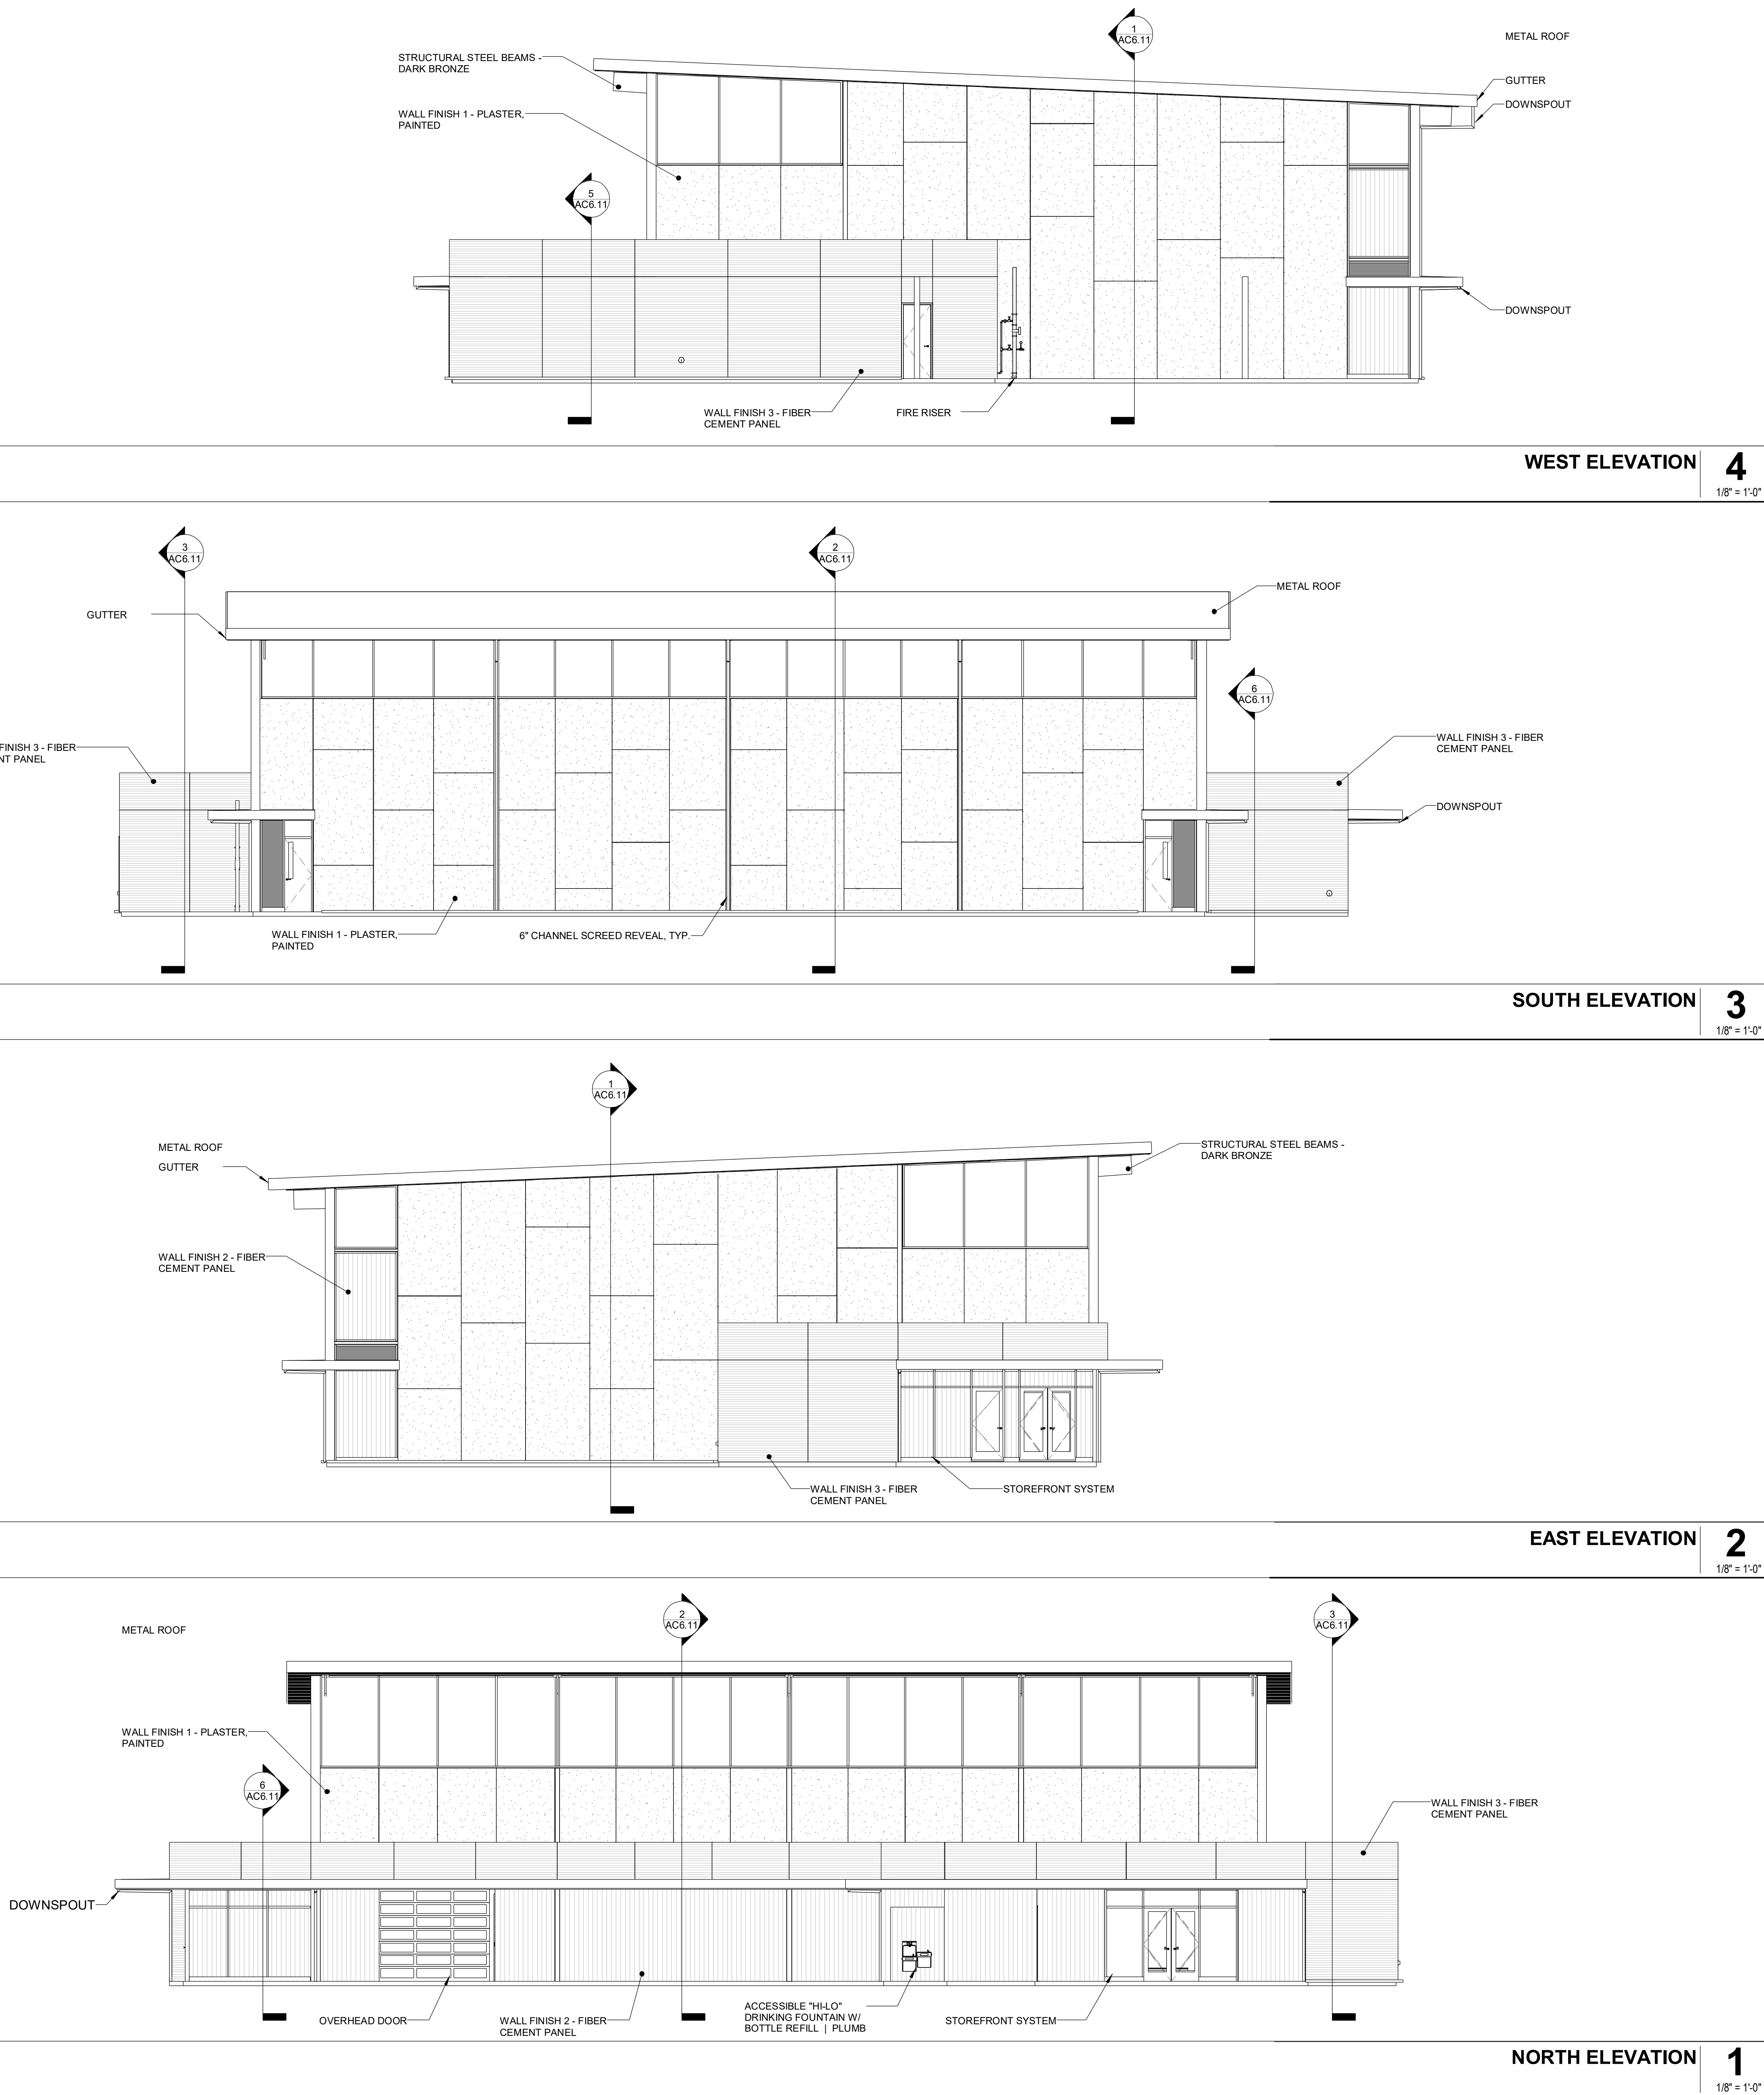

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KEYNOTES

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FACILITY:  
**WEBER INSTITUTE OF APPLIED SCIENCES & TECHNOLOGY**  
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STOCKTON, CA 95203

PROJECT:  
**STOCKTON USD WEBER INSTITUTE GYMNASIUM**

SHEET NAME:  
**BUILDING C - EXTERIOR ELEVATIONS**

**DESIGN DEVELOPMENT**

DATE: 4/15/2025  
CLIENT PROJ NO:


SHEET:

AC5.11




AutoDesk Docs:\3271016000 Stockton USD Weber Institute Gymnasium\3271016000-A-WEBER-INST-SITE.rvt 4/17/2025 7:00:24 AM

ALL LINE SHOWN AND OTHERS  
EXCEPTED ORIGINAL SIZE  
SHEET ORIGINAL SIZE

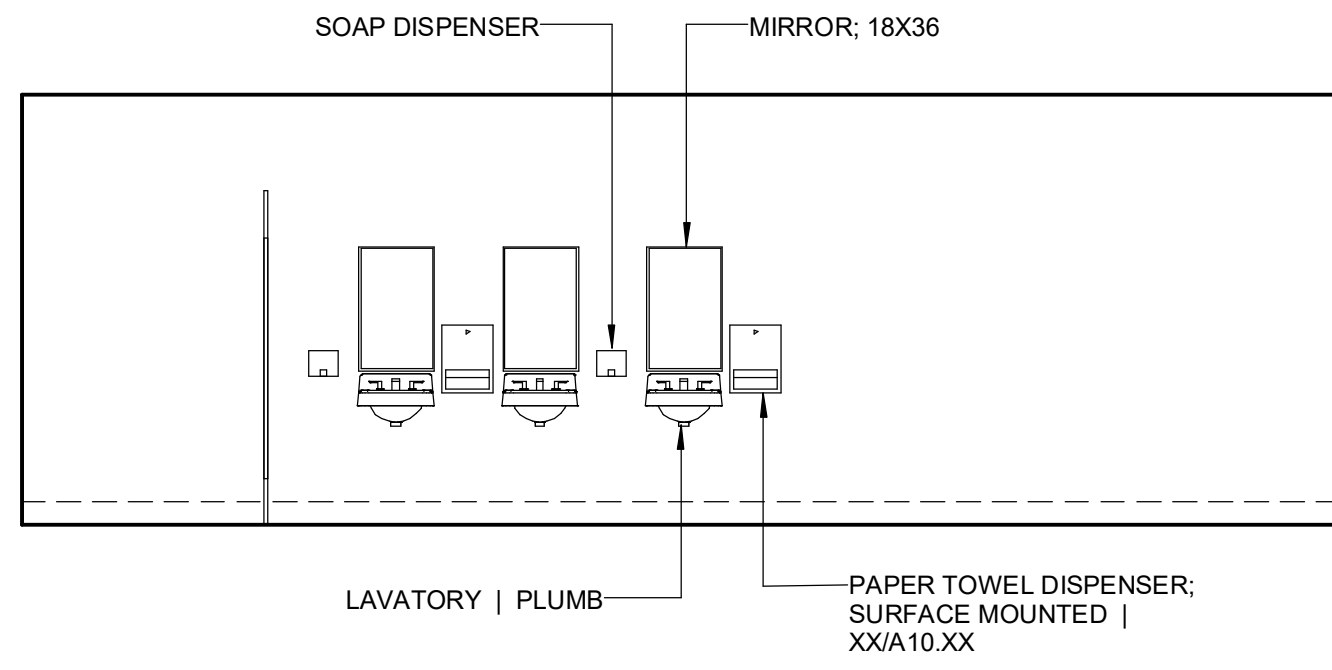


119 RESTROOM 4 **2D**  
1/4" = 1'-0"


GRAB BAR, 36" MIN AT REAR  
WALL & 42" MIN AT SIDE WALL  
| XX/A10.XX

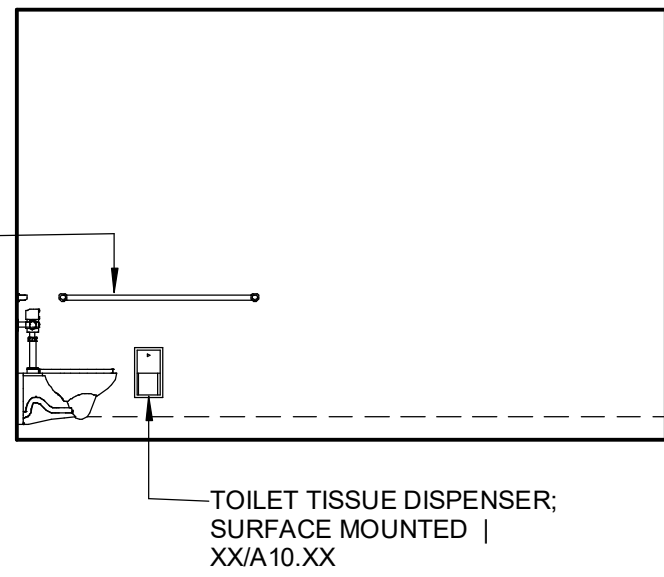


119 RESTROOM 3 **2C**  
1/4" = 1'-0"

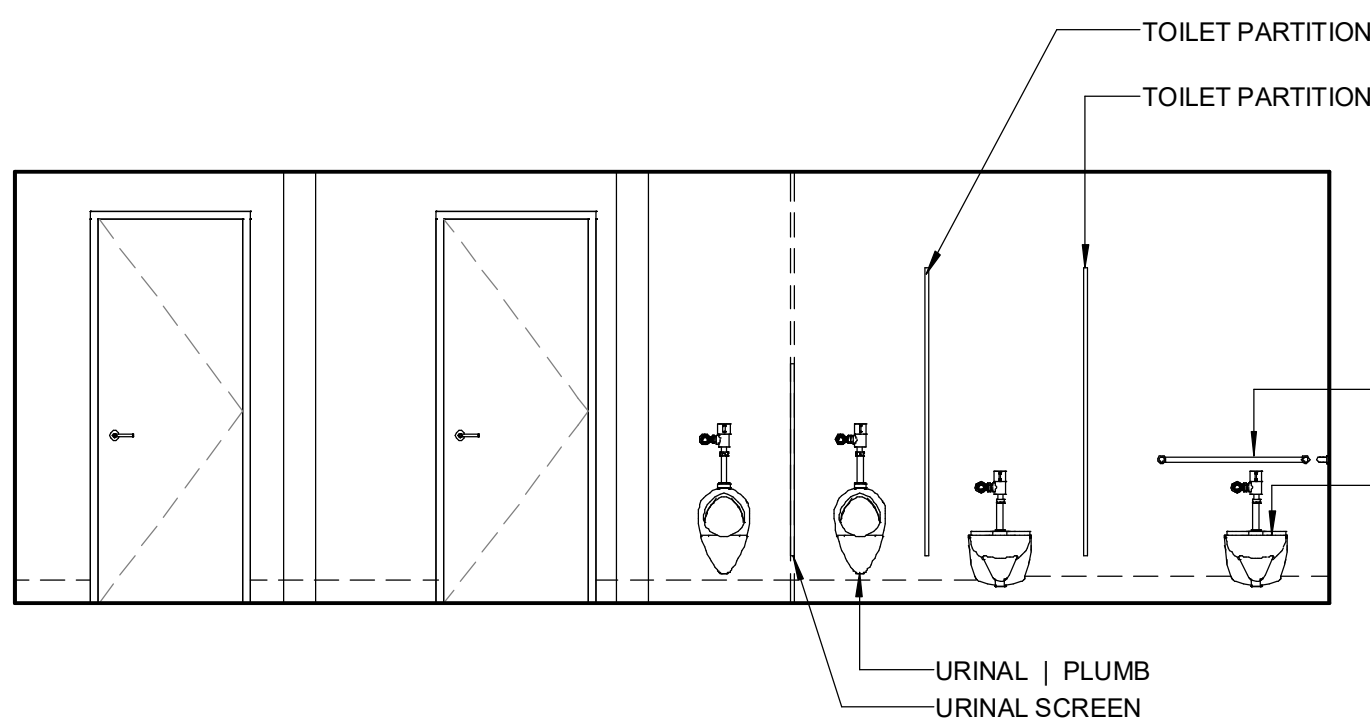

119 RESTROOM 2 **2B**  
1/4" = 1'-0"

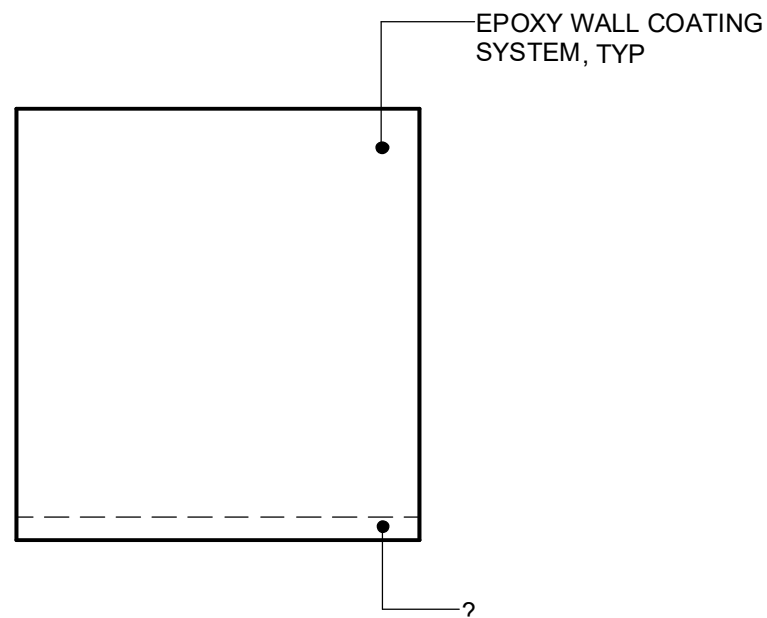


119 RESTROOM 1 **2A**  
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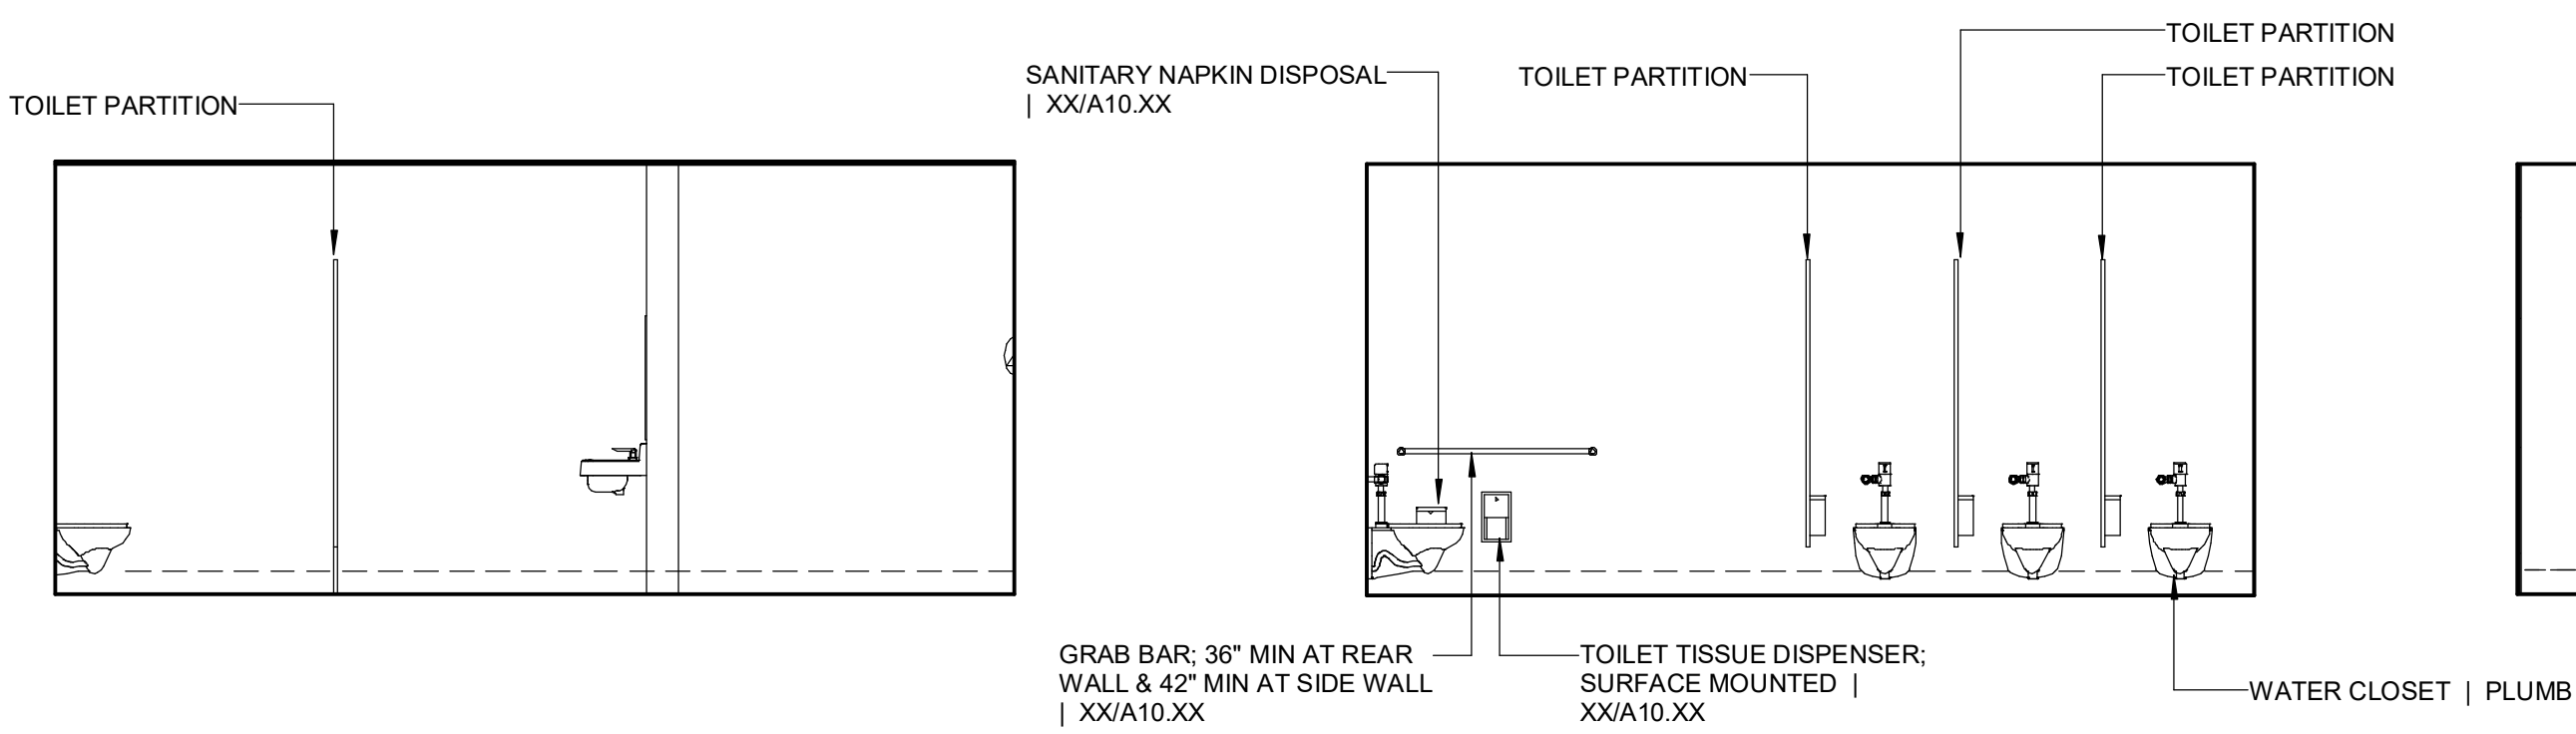
116 RESTROOM 4A **1F**  
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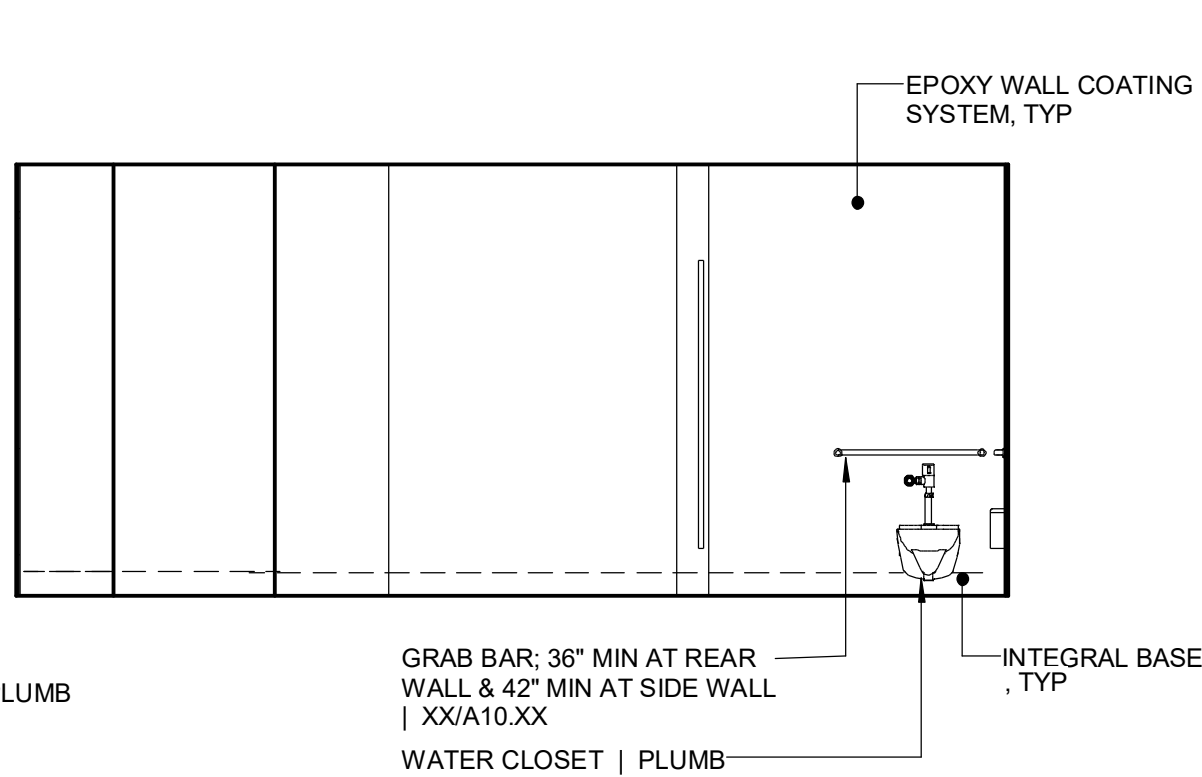
116 RESTROOM 1A **1E**  
1/4" = 1'-0"

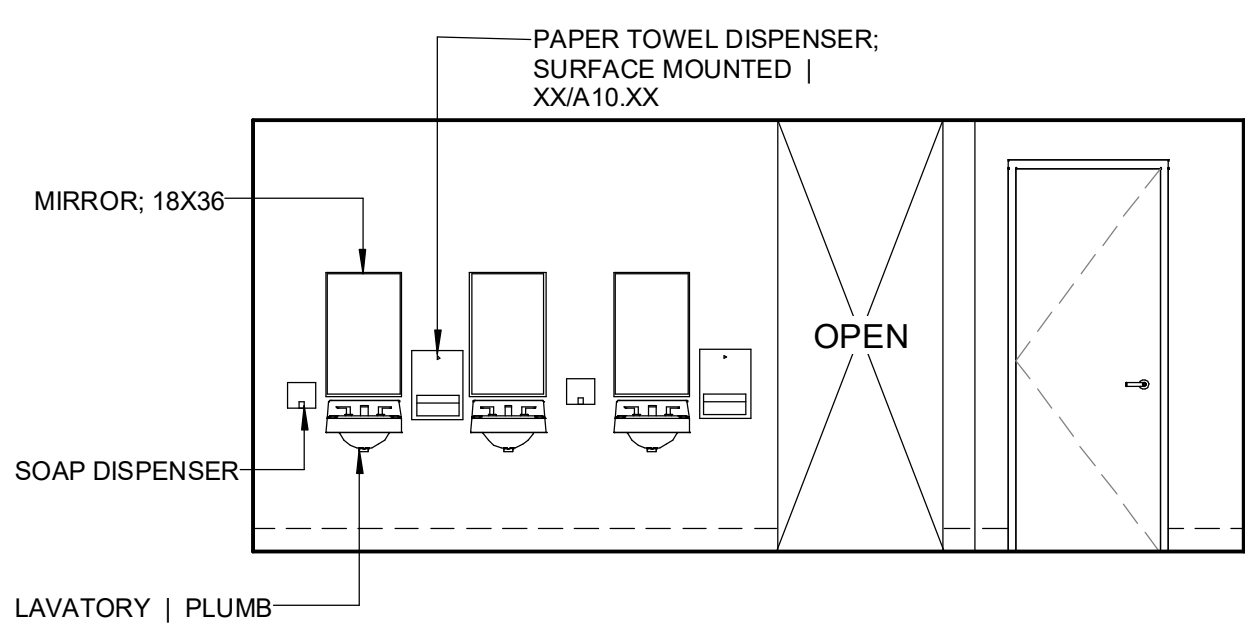

116 RESTROOM 4 **1D**  
1/4" = 1'-0"




116 RESTROOM 3 **1C**  
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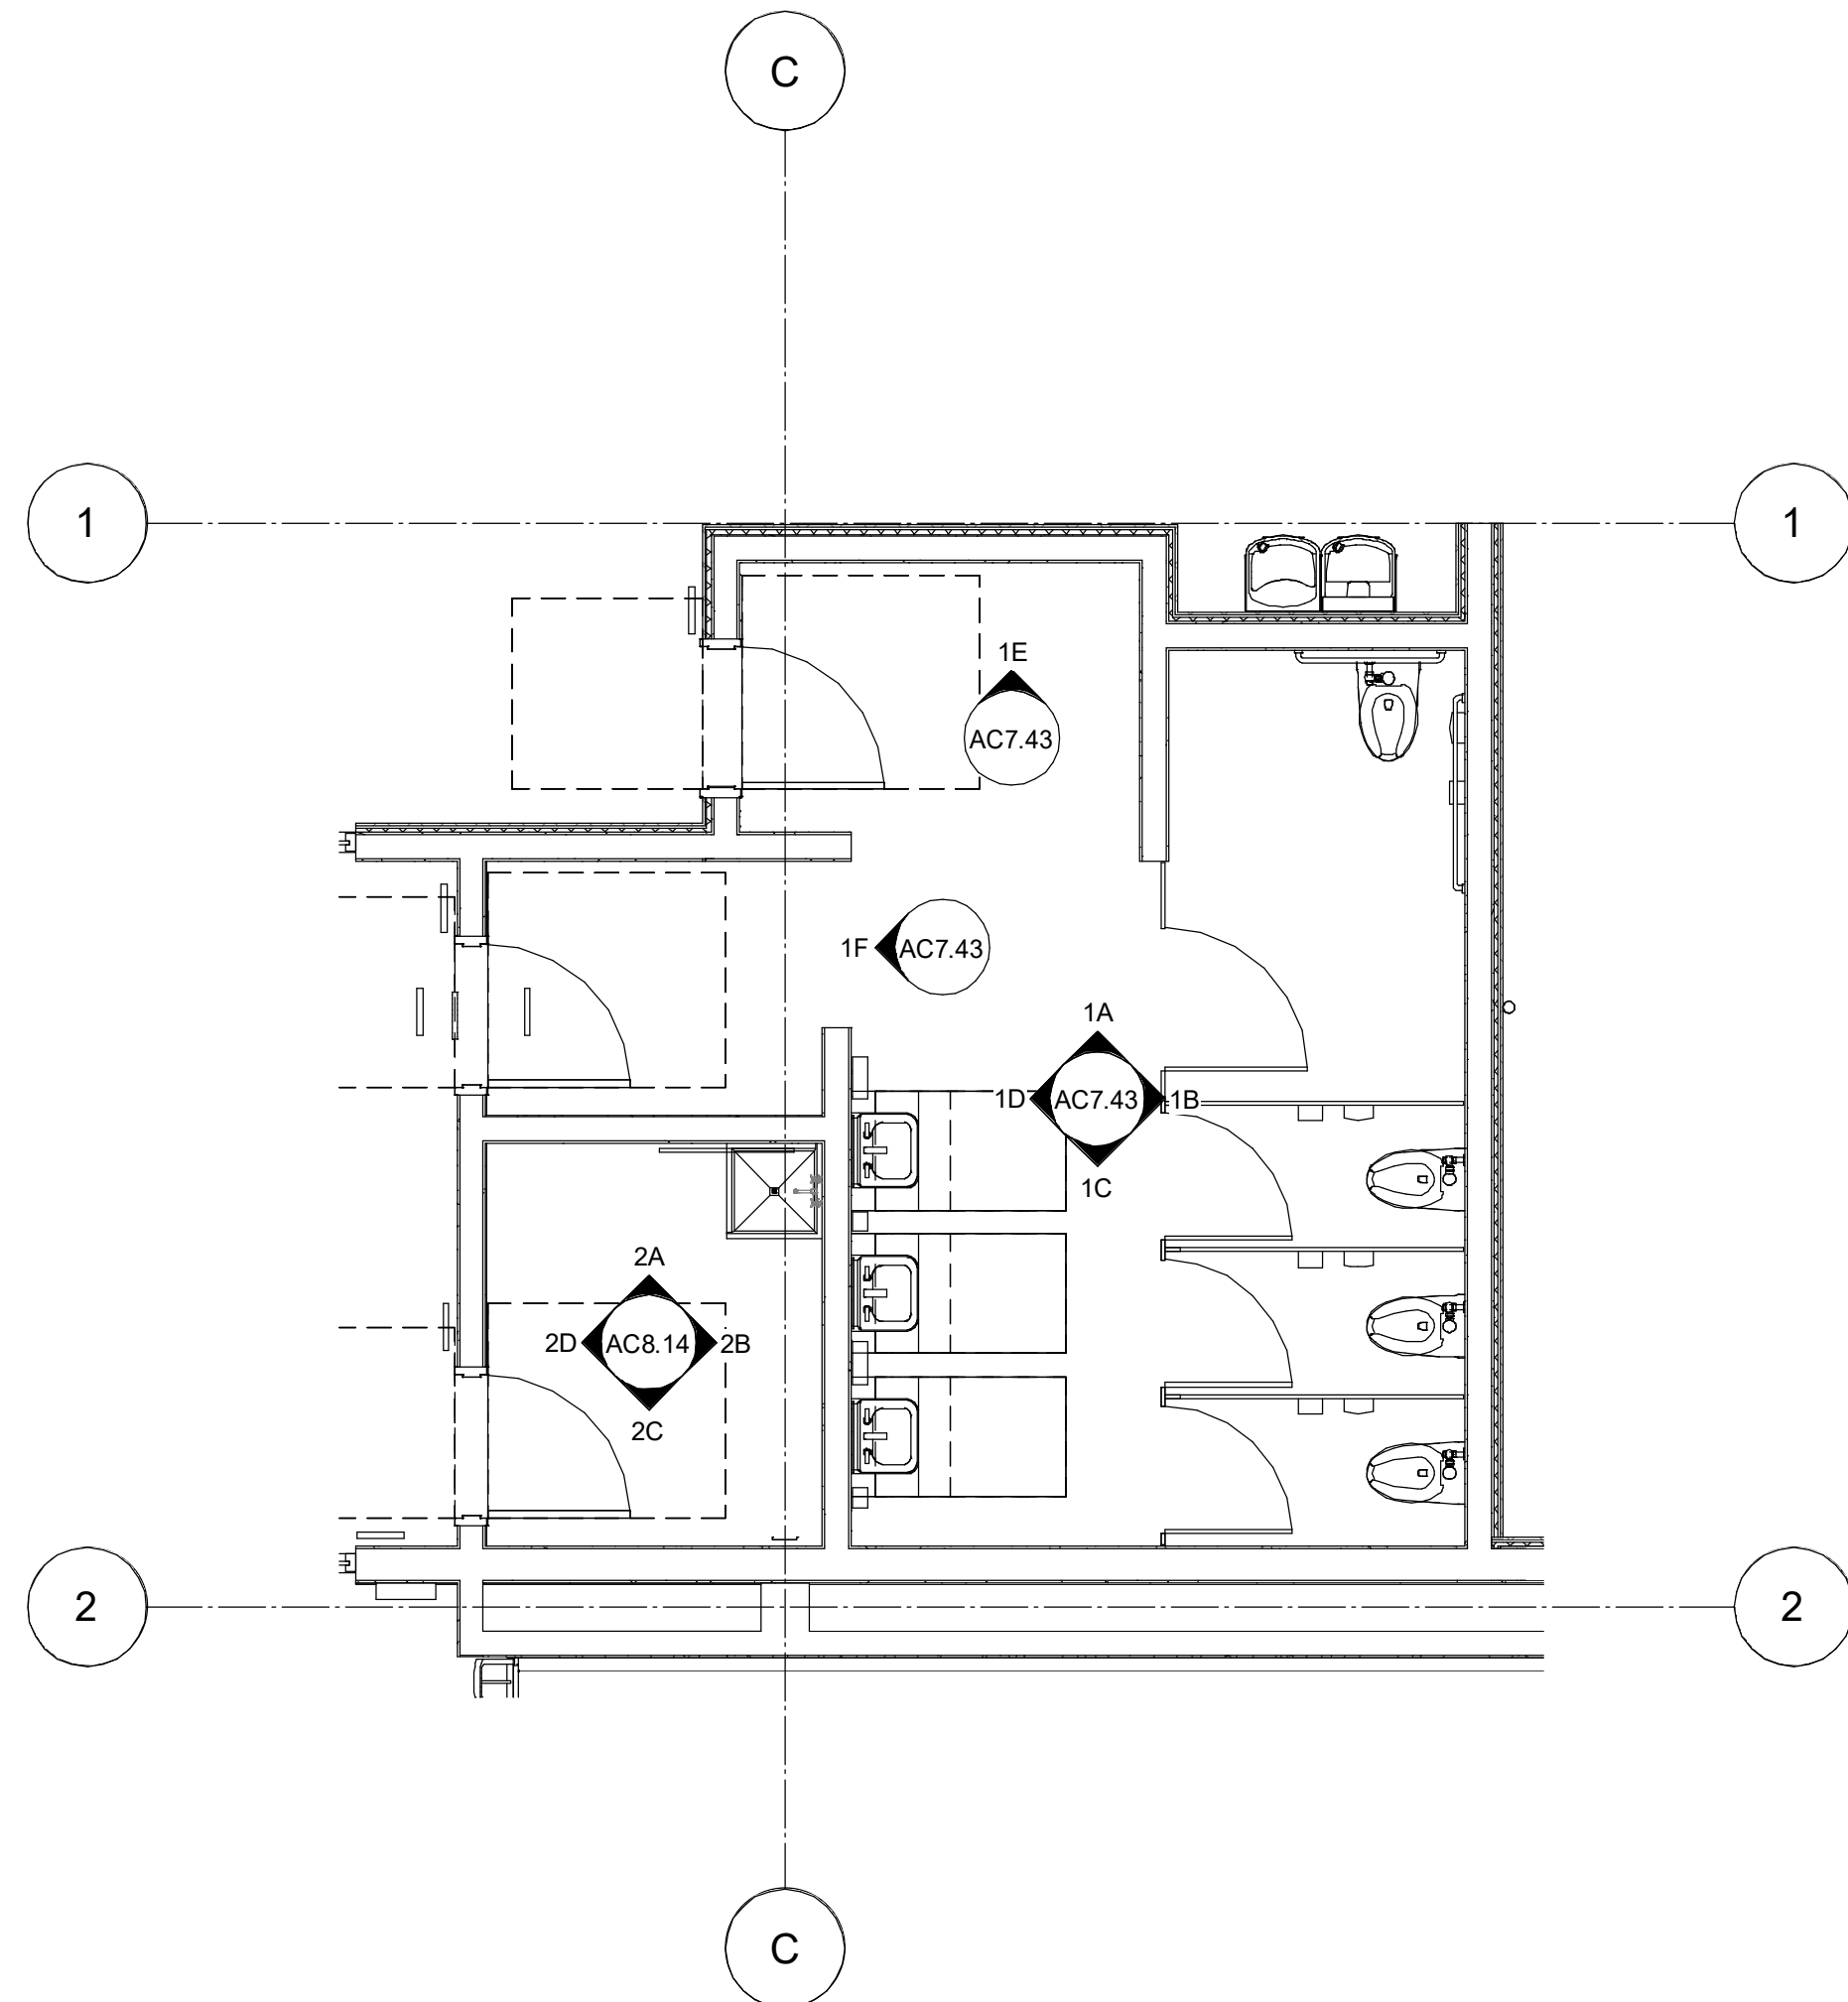


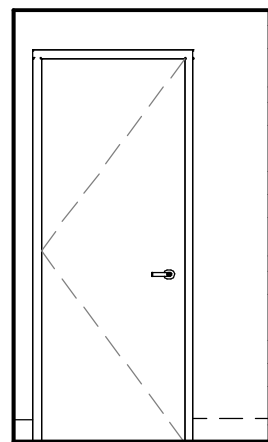116 RESTROOM 2 **1B**  
1/4" = 1'-0"

116 RESTROOM 1 **1A**  
1/4" = 1'-0"

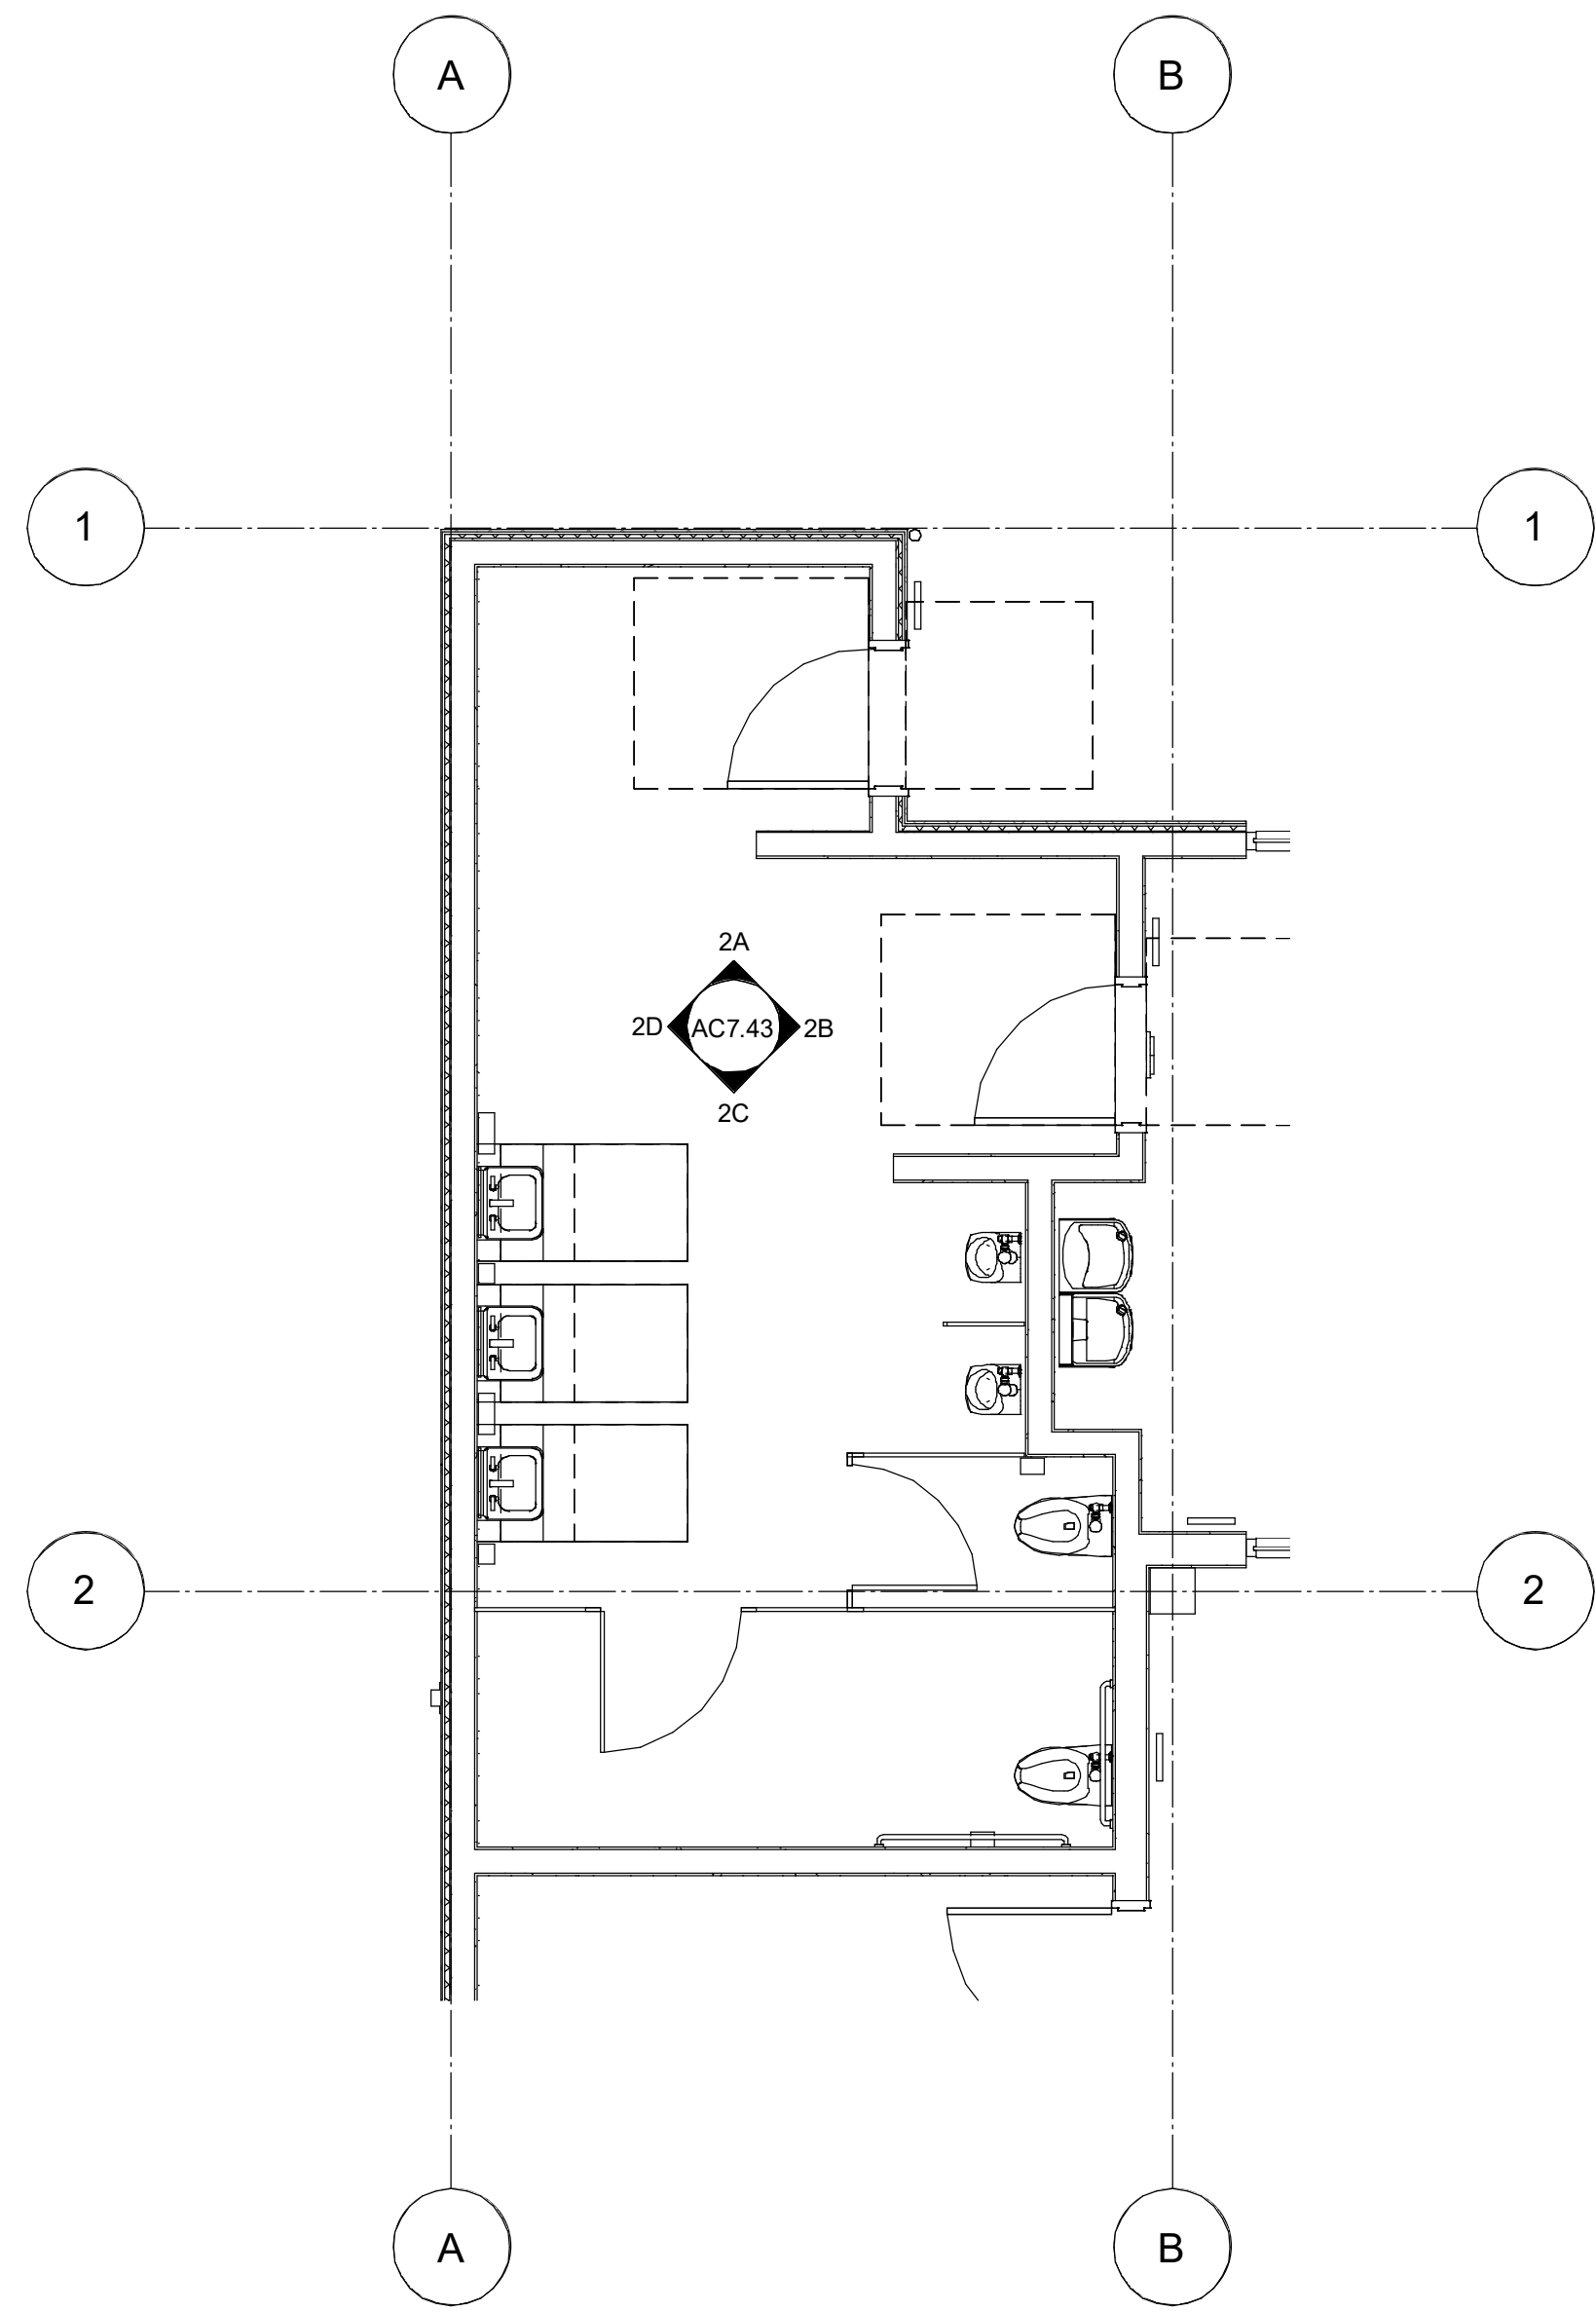

ENLARGED VIEW - RR1 **2**  
1/4" = 1'-0"



ENLARGED VIEW - RR2 **1**  
1/4" = 1'-0"



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DESCRIPTION DATE

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#### KEYNOTES

#### NOTES

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WEBER INSTITUTE OF APPLIED SCIENCES & TECHNOLOGY  
302 W WEBER AVE,  
STOCKTON, CA 95203

PROJECT:  
STOCKTON USD WEBER INSTITUTE GYMNASIUM

SHEET NAME:  
ENLARGED PLAN & ELEVATIONS


DESIGN DEVELOPMENT

DATE: 4/15/2025  
CLIENT PROJ NO:


SHEET:

AC7.43



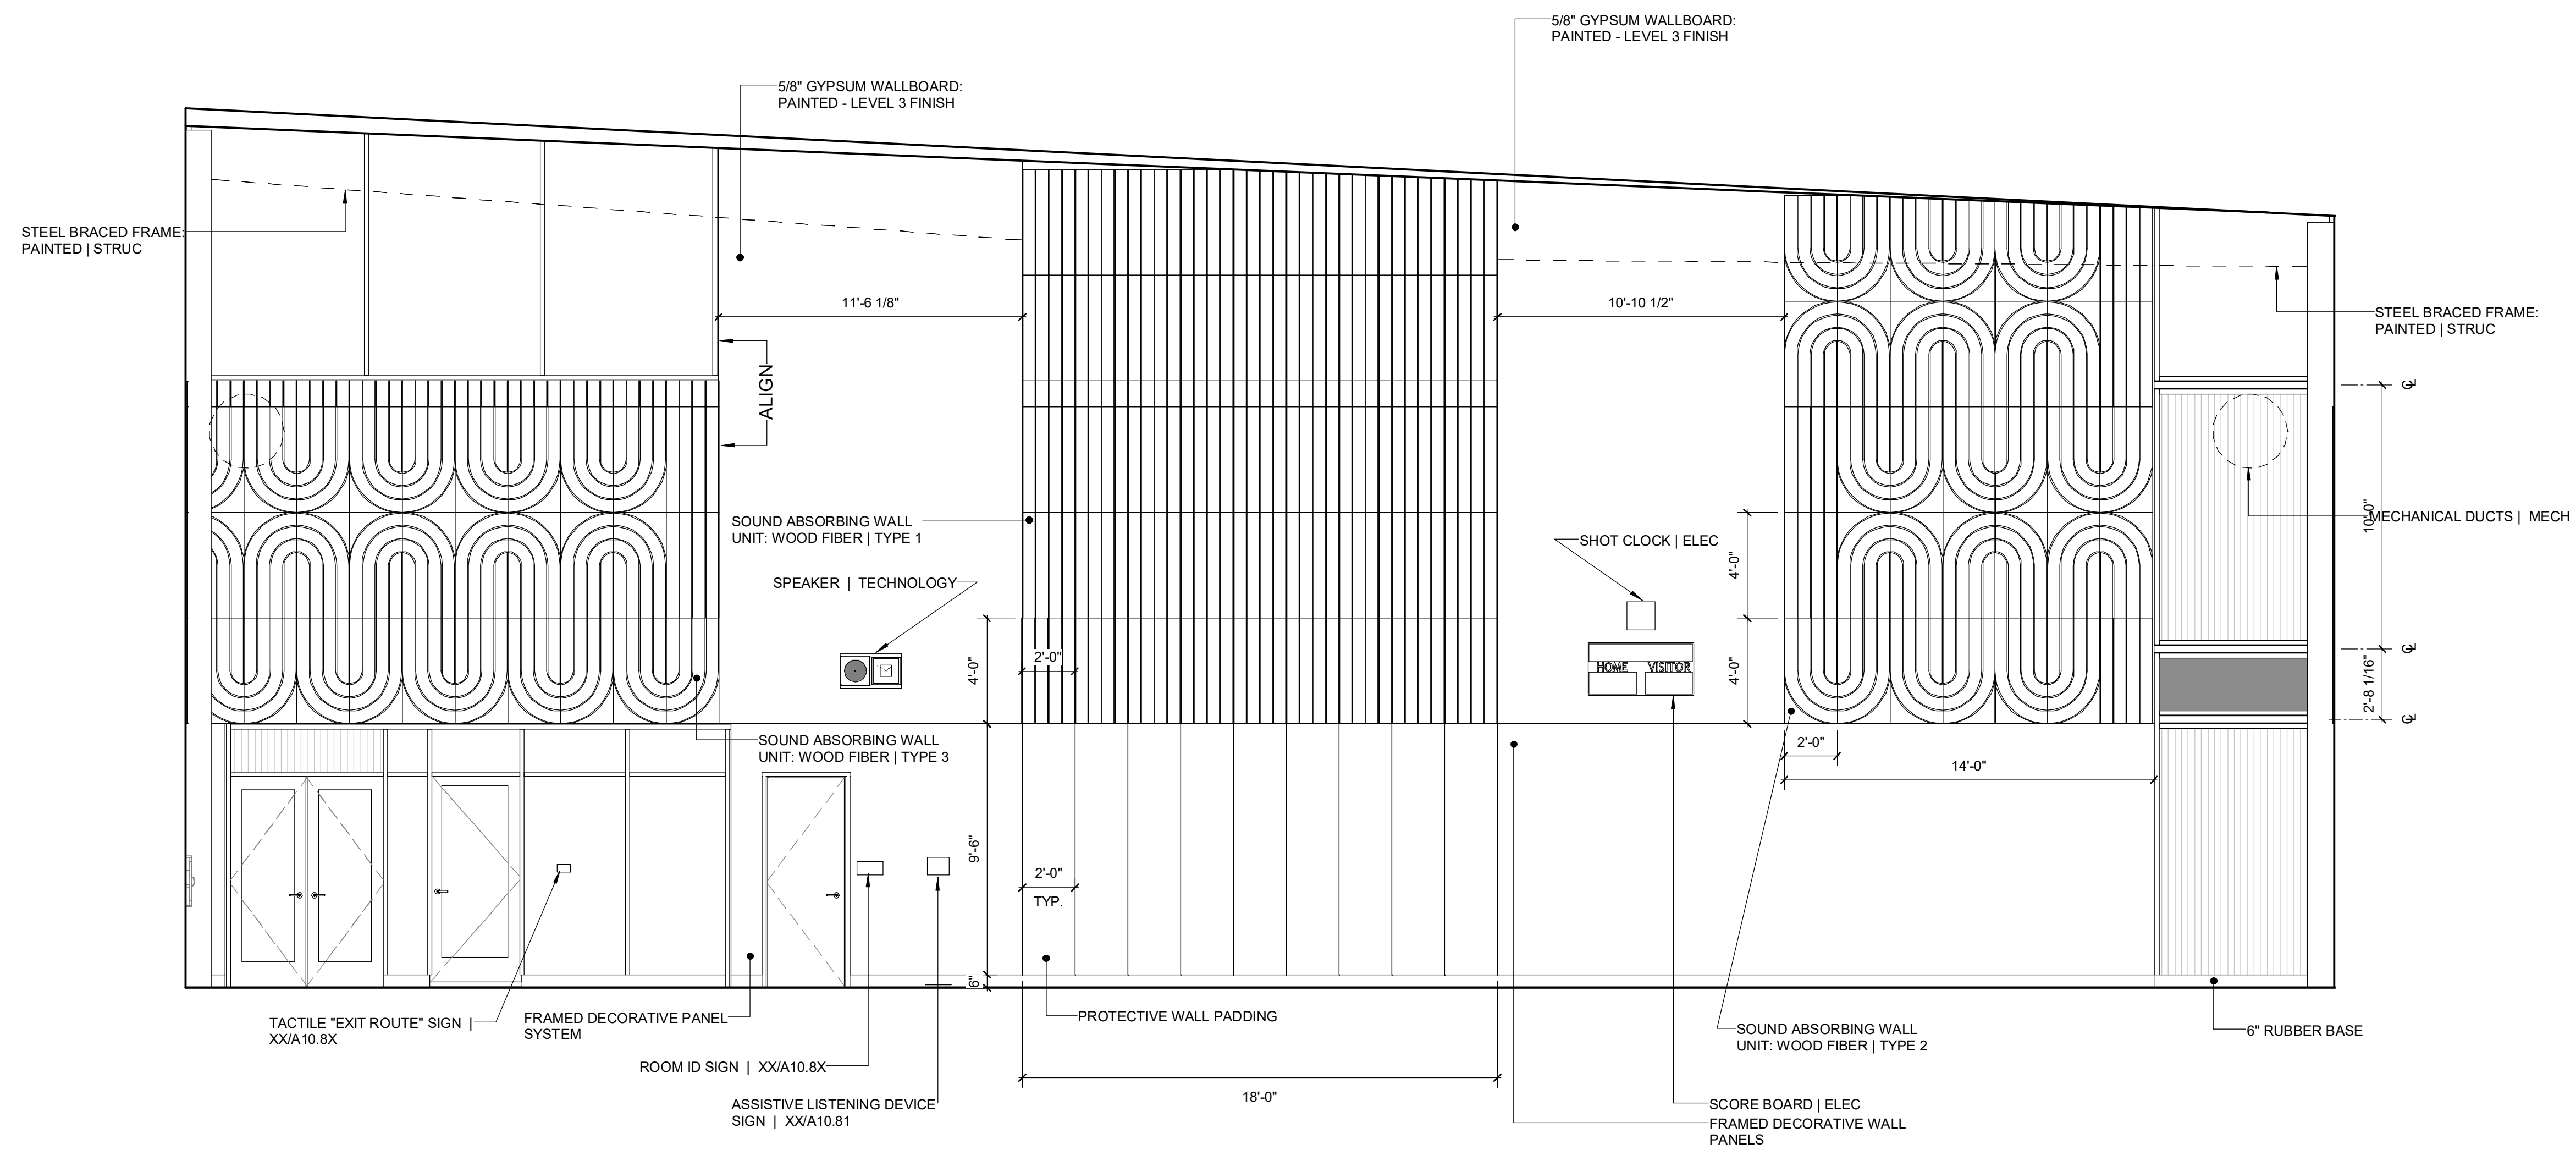

114 GYM 2 | 2  
1/4" = 1'-0"

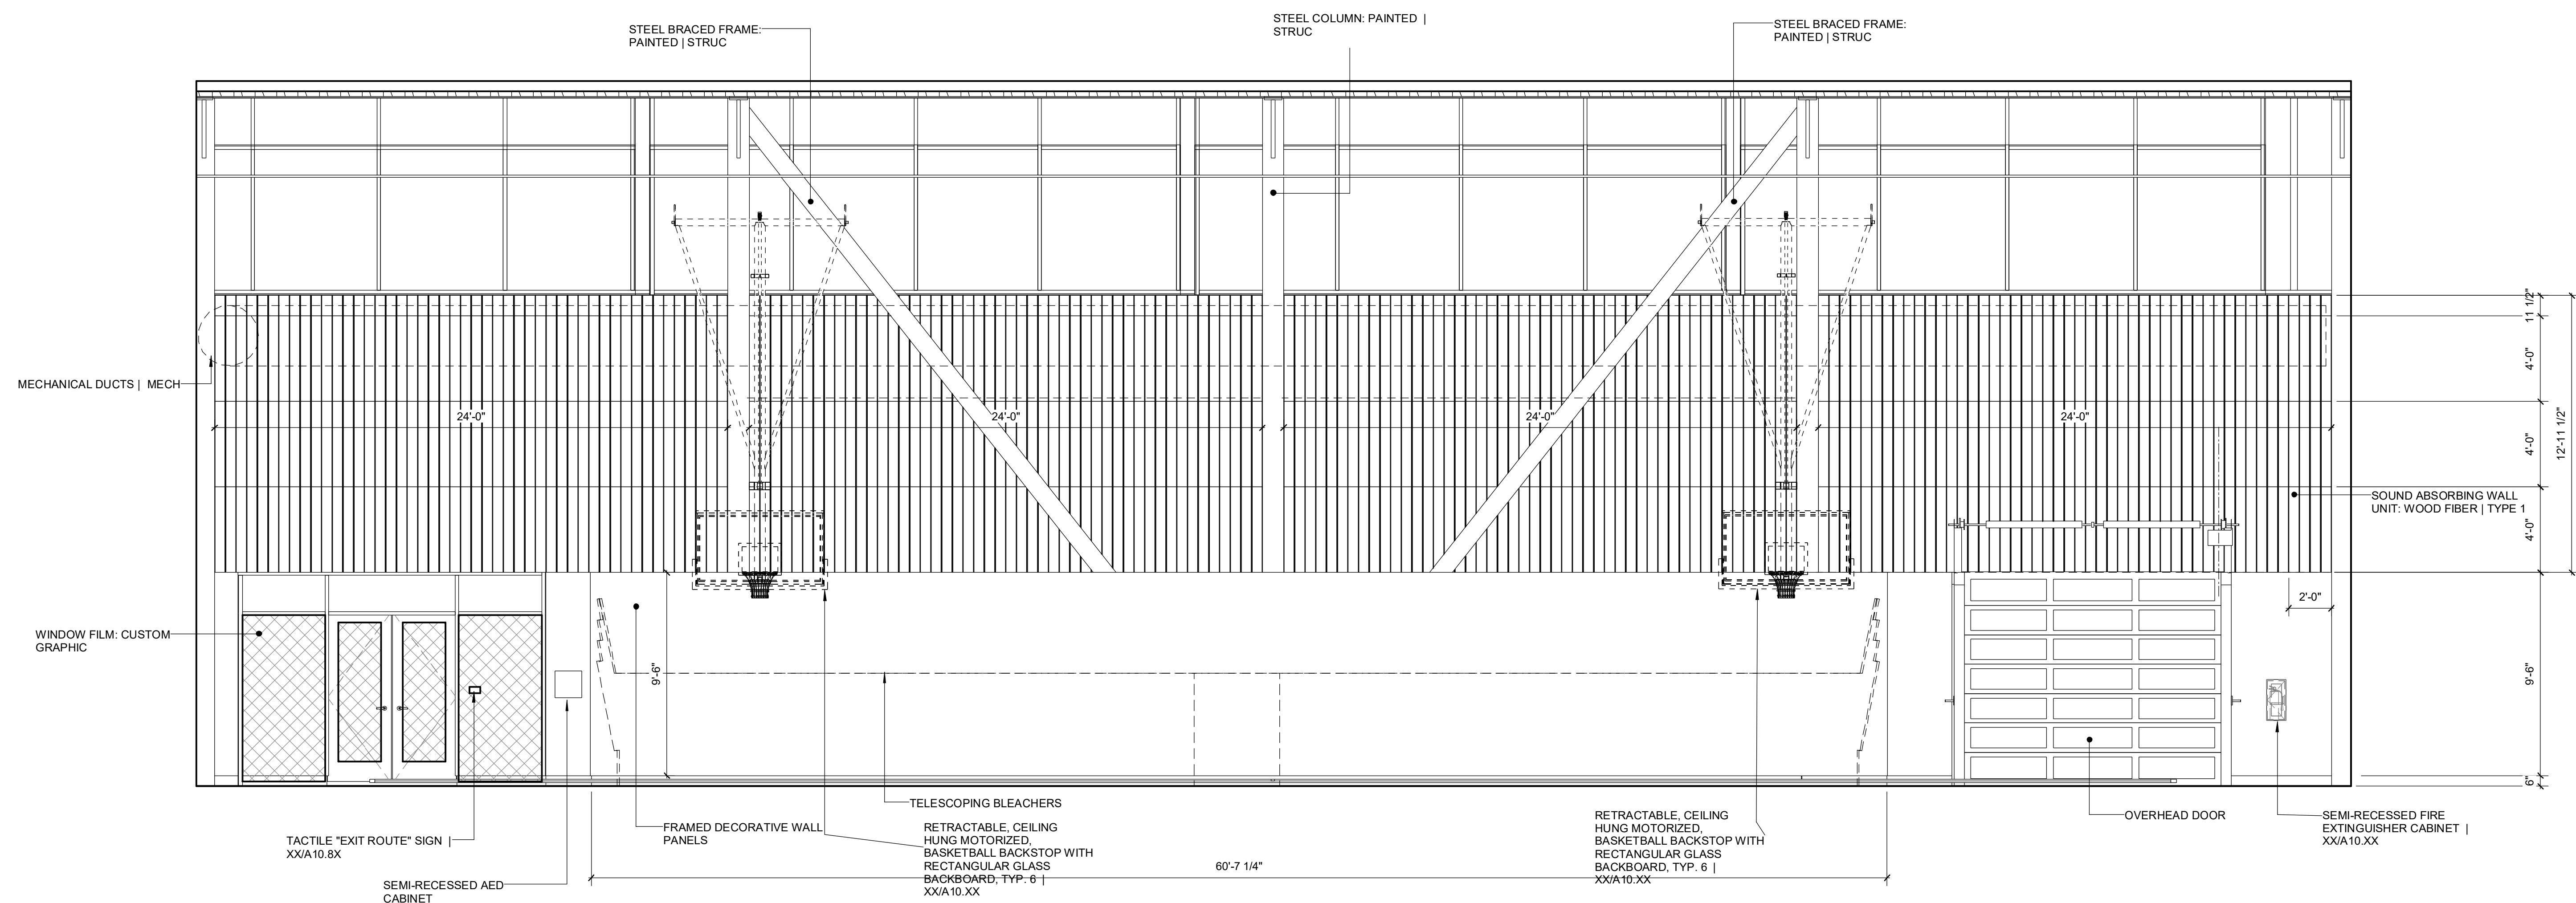

114 GYM 1 **1**  
1/4" = 1'-0"



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## KEYNOTES

## NOTES

**FACILITY:**  
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**302 W WEBER AVE,**  
**STOCKTON, CA 95203**

PROJECT:  
**STOCKTON USD WEBER INSTITUTE GYMNASIUM**

SHEET NAME:  
**INTERIOR ELEVATIONS - BUILDING C**

## DESIGN DEVELOPMENT

DATE: 4/15/2025	CLIENT PROJ NO:
SHEET:	

SHEET: \_\_\_\_\_


SHEET: \_\_\_\_\_

## AC8.12



AutoDesk Docs:\3271016000 Stockton USD Weber Institute Gymnasium\3271016000-A-WEBER-INST-SITE.rvt 4/17/2025 7:00:25 AM

ALL LINES SHOWN AND VERTICAL DIMENSIONS ARE TO FACE UNLESS NOTED OTHERWISE. SHEET ORIGINAL PAGE SIZE

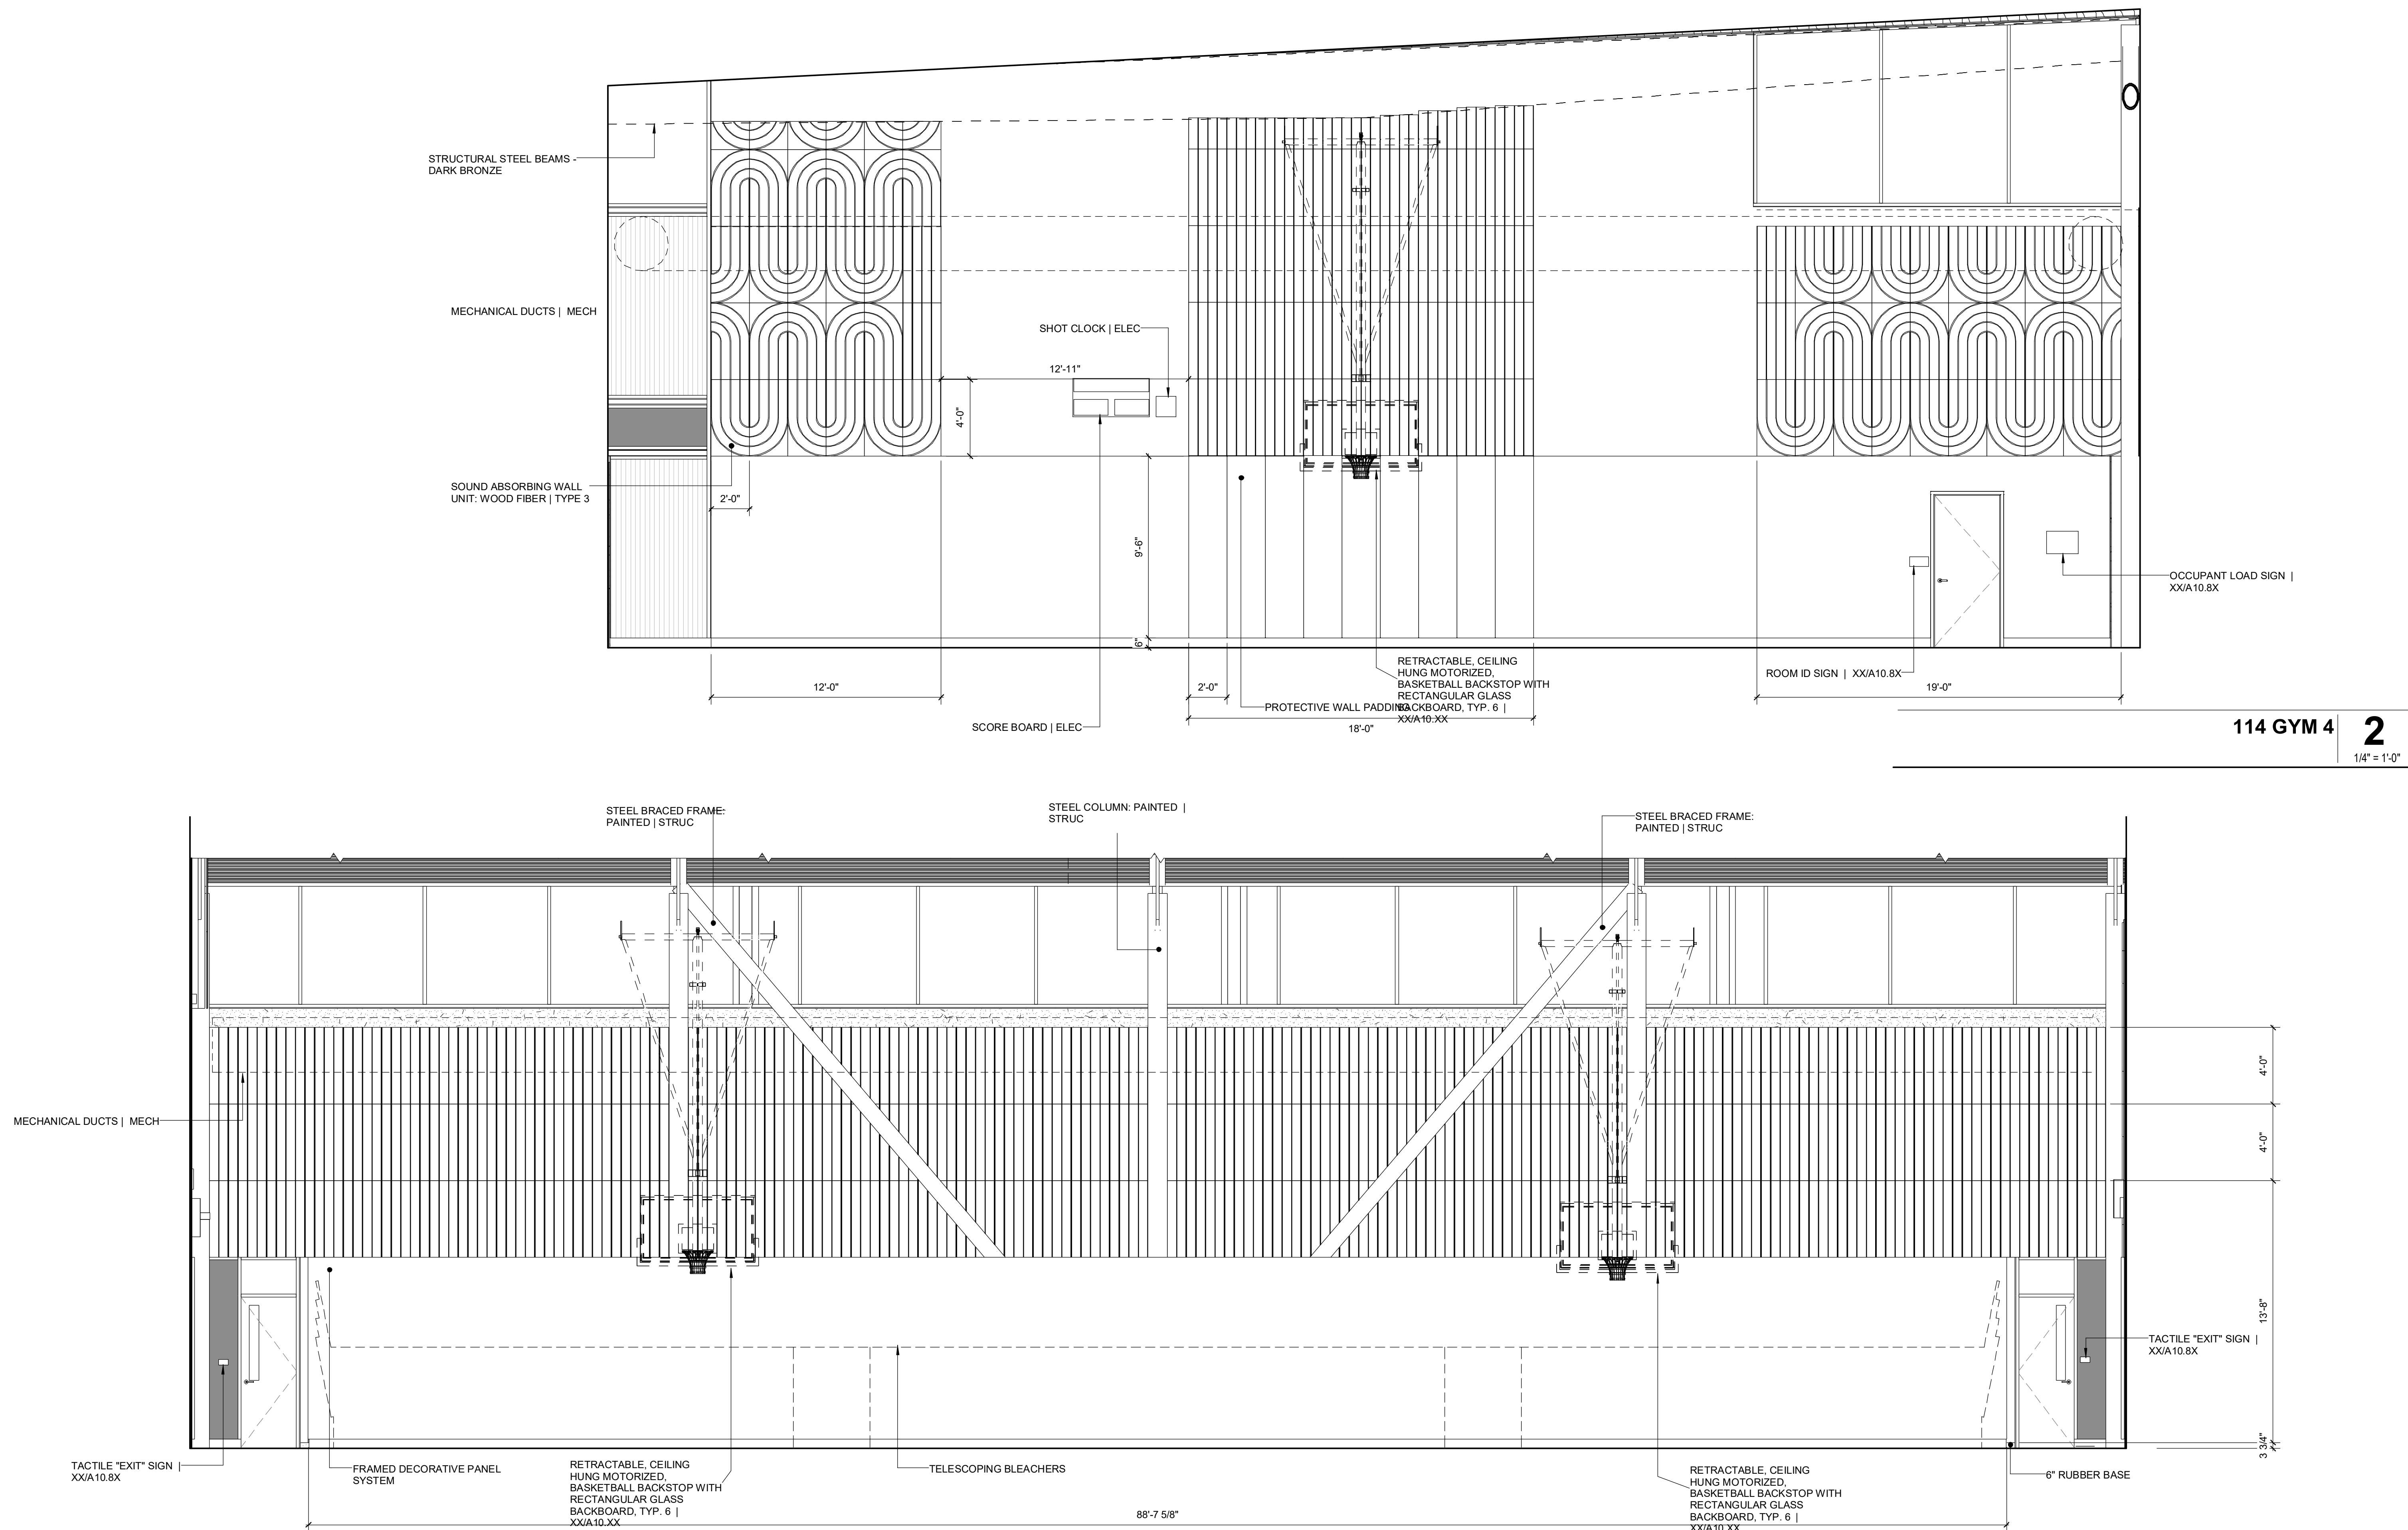

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PROJECT:  
**STOCKTON USD WEBER INSTITUTE GYMNASIUM**

SHEET NAME:  
**INTERIOR ELEVATIONS - BUILDING C**

**DESIGN DEVELOPMENT**

DATE: 4/15/2025 CLIENT PROJ NO:  
SHEET:

114 GYM 4  
2  
1/4" = 1'-0"

114 GYM 3  
1  
1/4" = 1'-0"


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AC8.13




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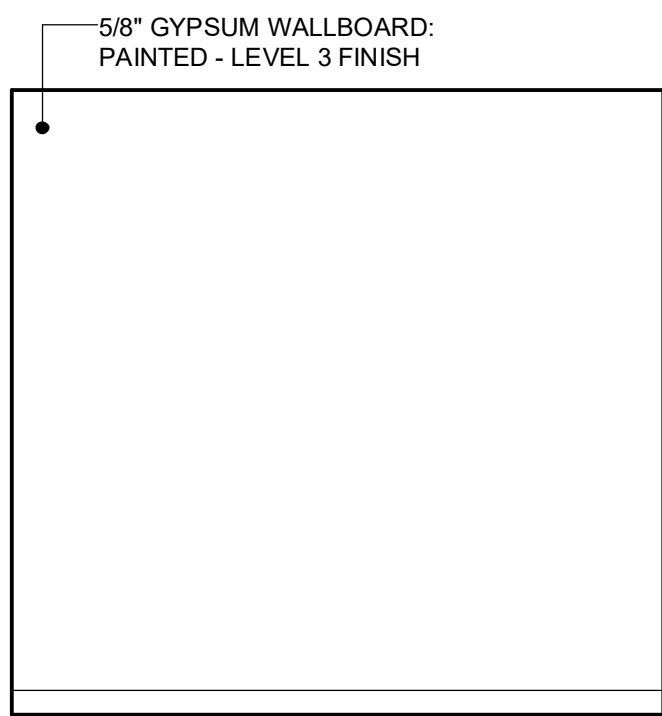
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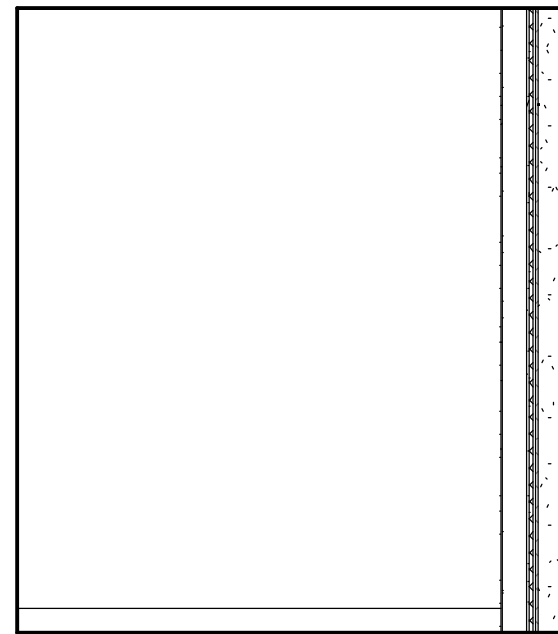
VESTIBULE 122 1 **6A**  
1/4" = 1'-0"




121 STORAGE 4 **5D**  
1/4" = 1'-0"

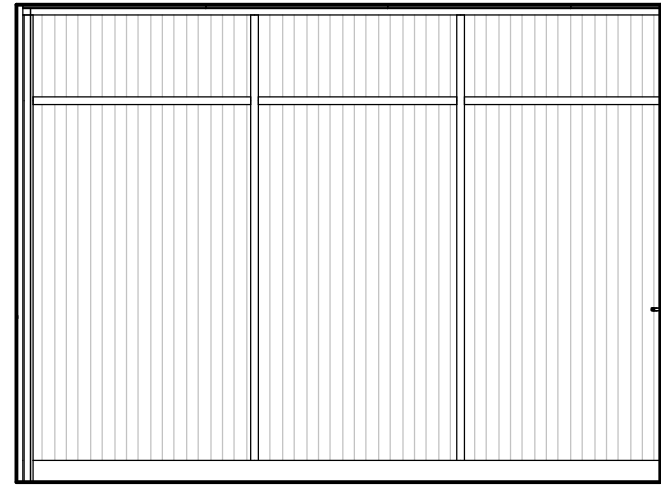

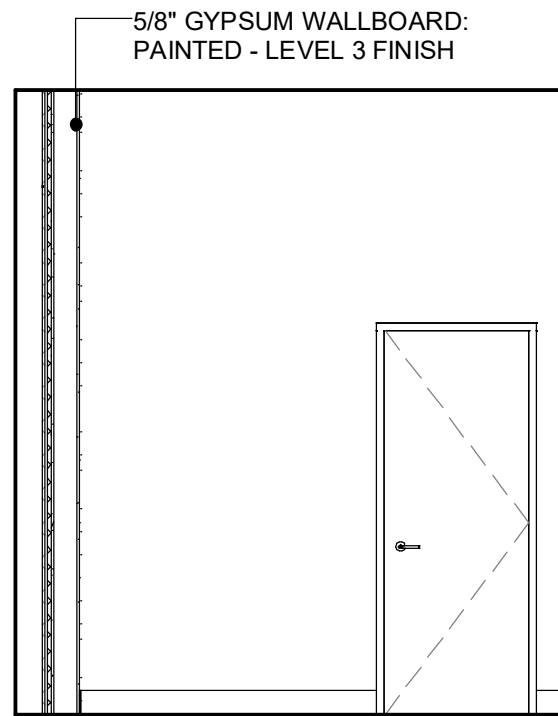
121 STORAGE 3 **5C**  
1/4" = 1'-0"




121 STORAGE 2 **5B**  
1/4" = 1'-0"

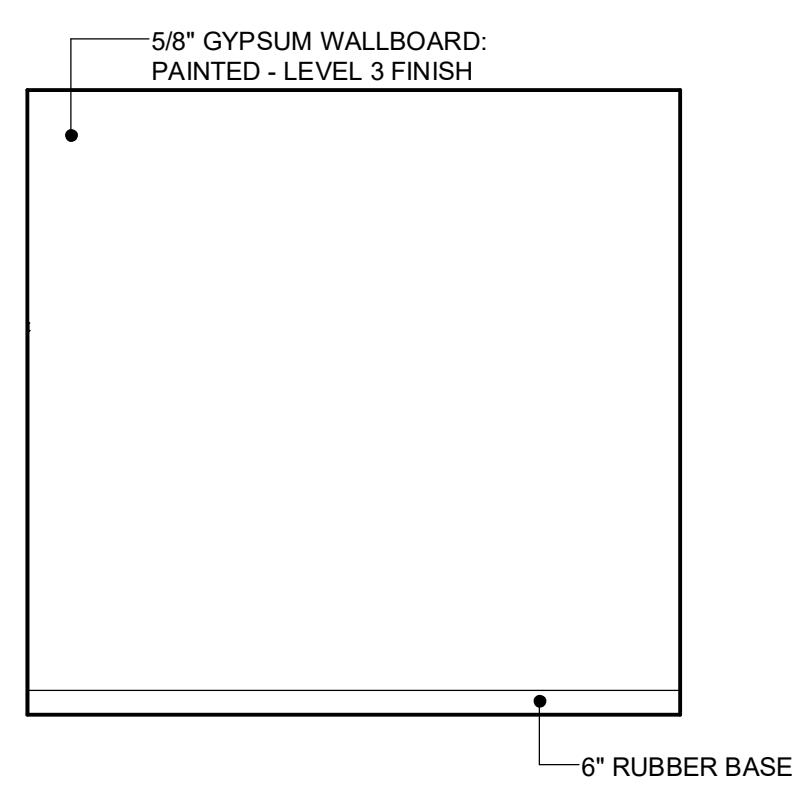


121 STORAGE 1 **5A**  
1/4" = 1'-0"

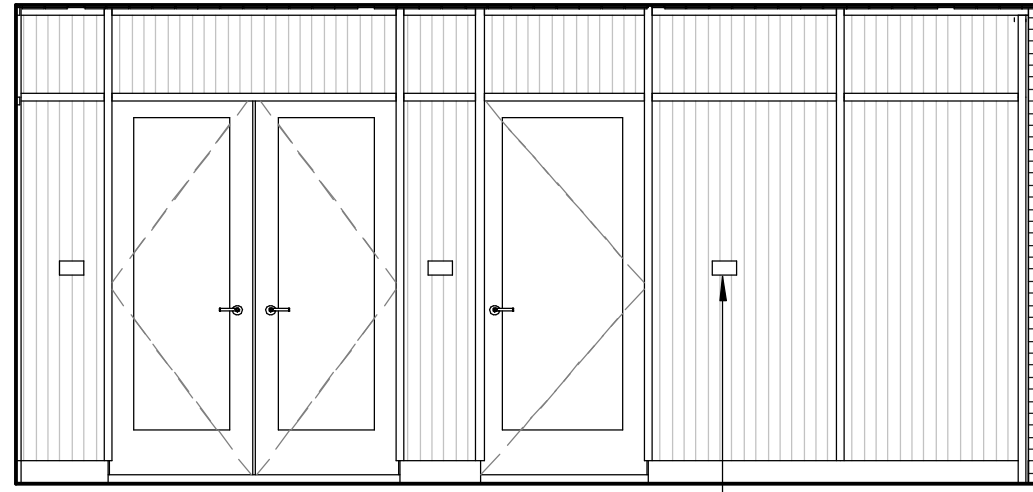


VESTIBULE 122 2 **6B**  
1/4" = 1'-0"

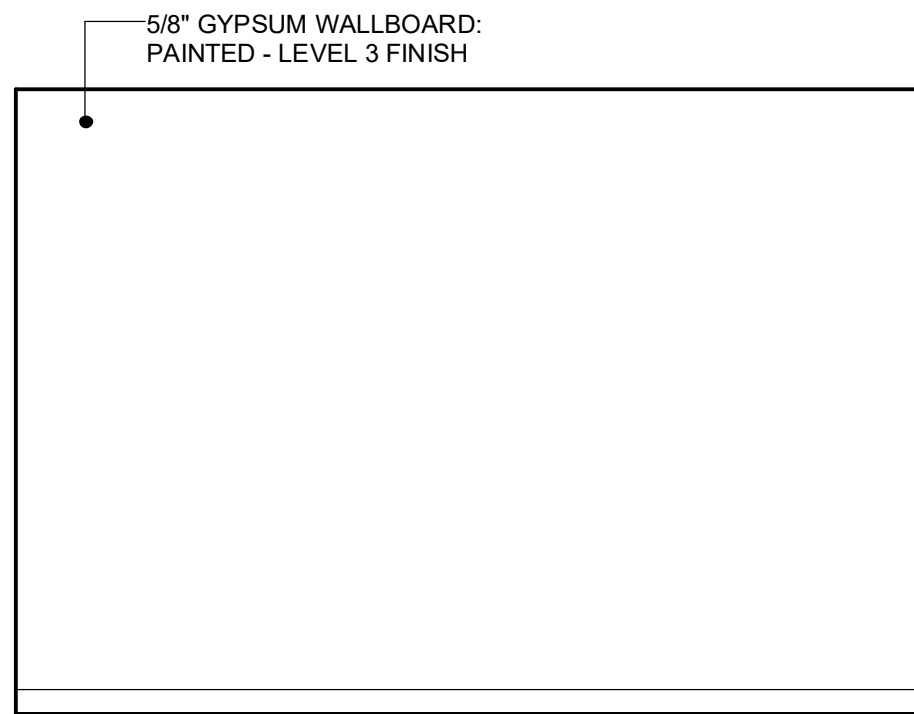


120 STORAGE 4 **4D**  
1/4" = 1'-0"

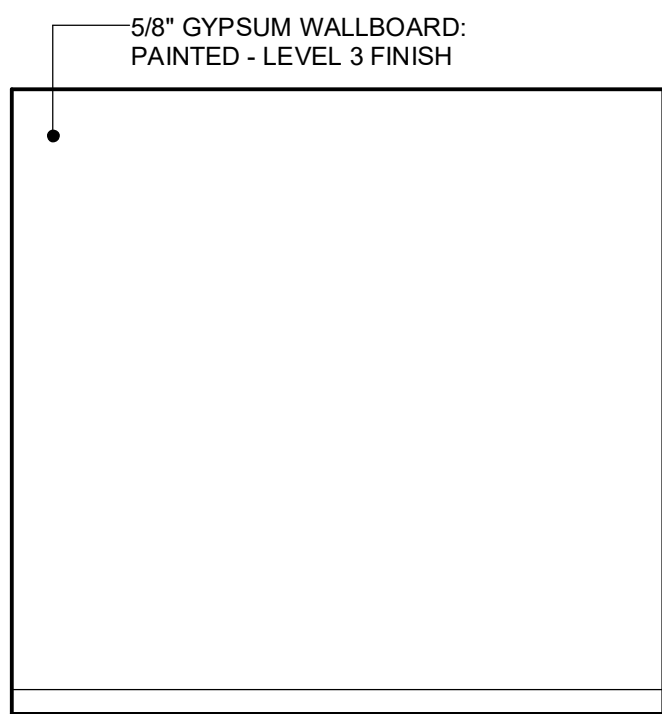


120 STORAGE 3 **4C**  
1/4" = 1'-0"

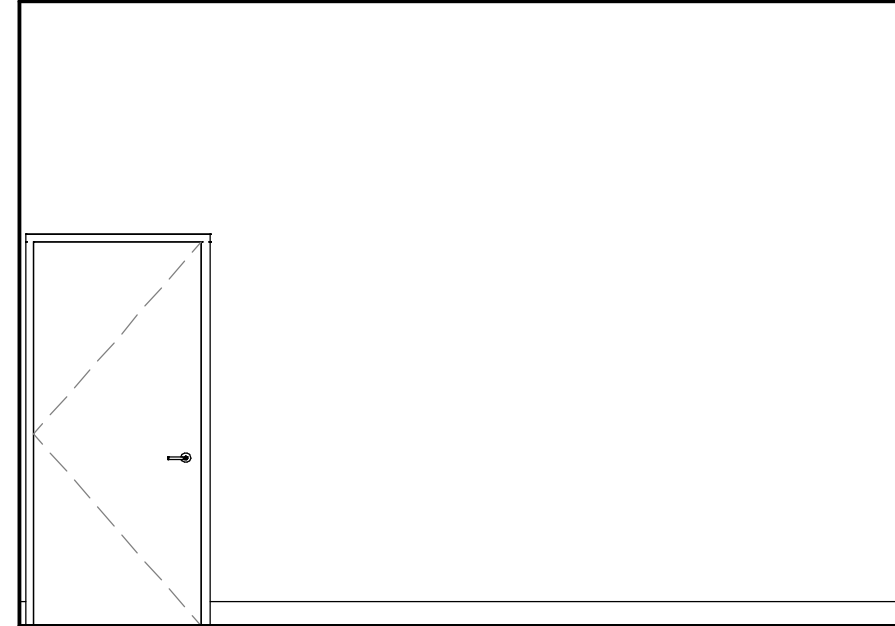


120 STORAGE 2 **4B**  
1/4" = 1'-0"

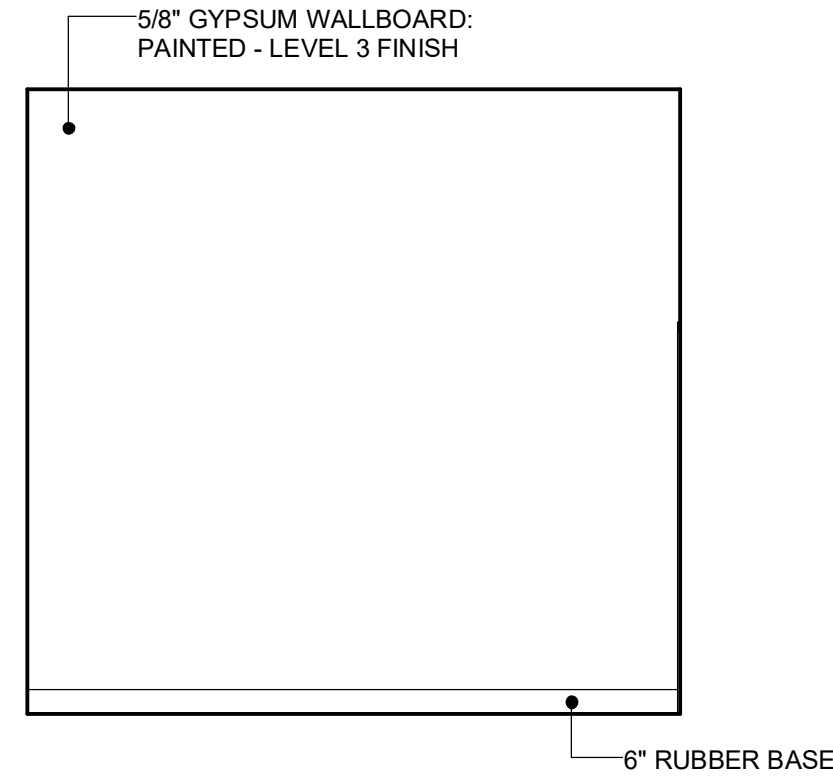


120 STORAGE 1 **4A**  
1/4" = 1'-0"

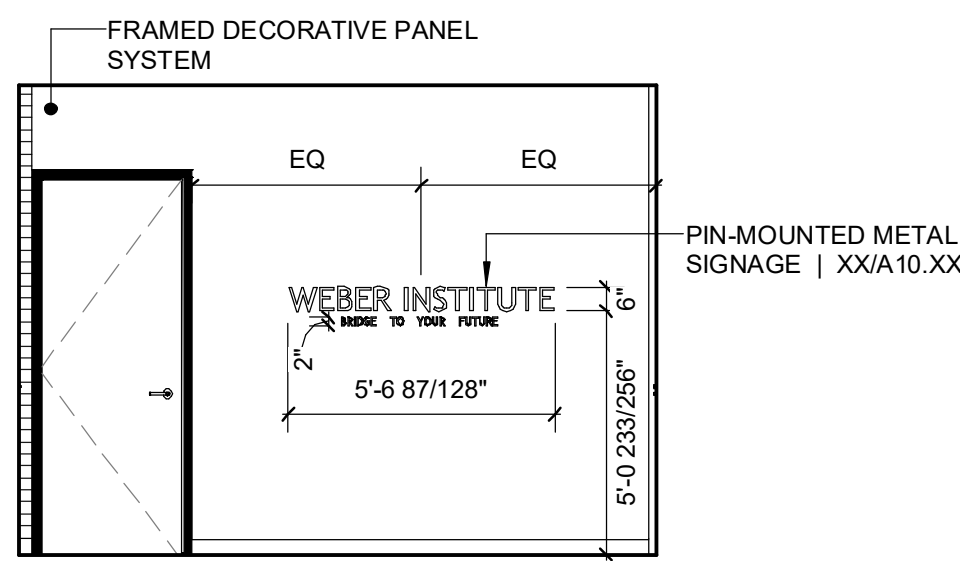


VESTIBULE 122 3 **6C**  
1/4" = 1'-0"

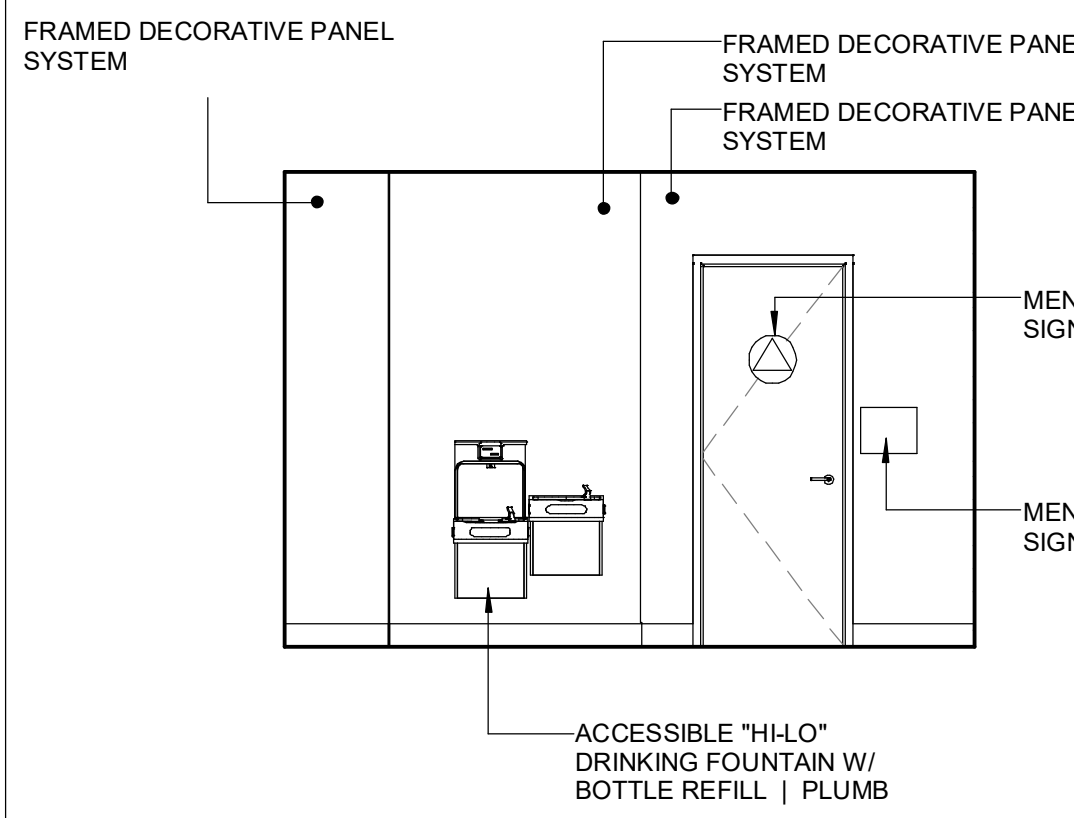


118 LOBBY 4 **3D**  
1/4" = 1'-0"

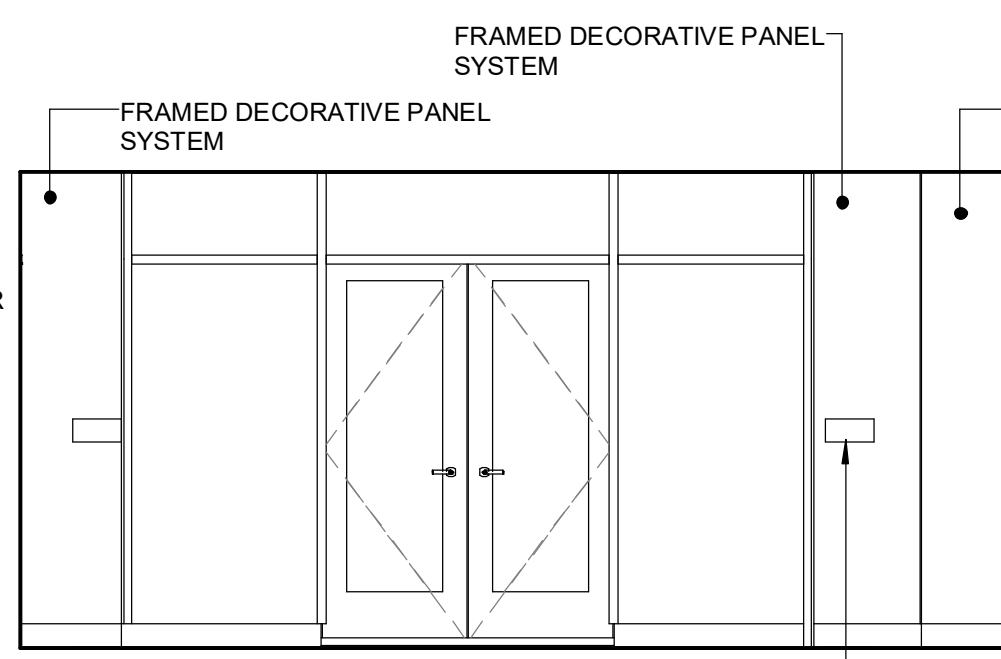


118 LOBBY 3 **3C**  
1/4" = 1'-0"

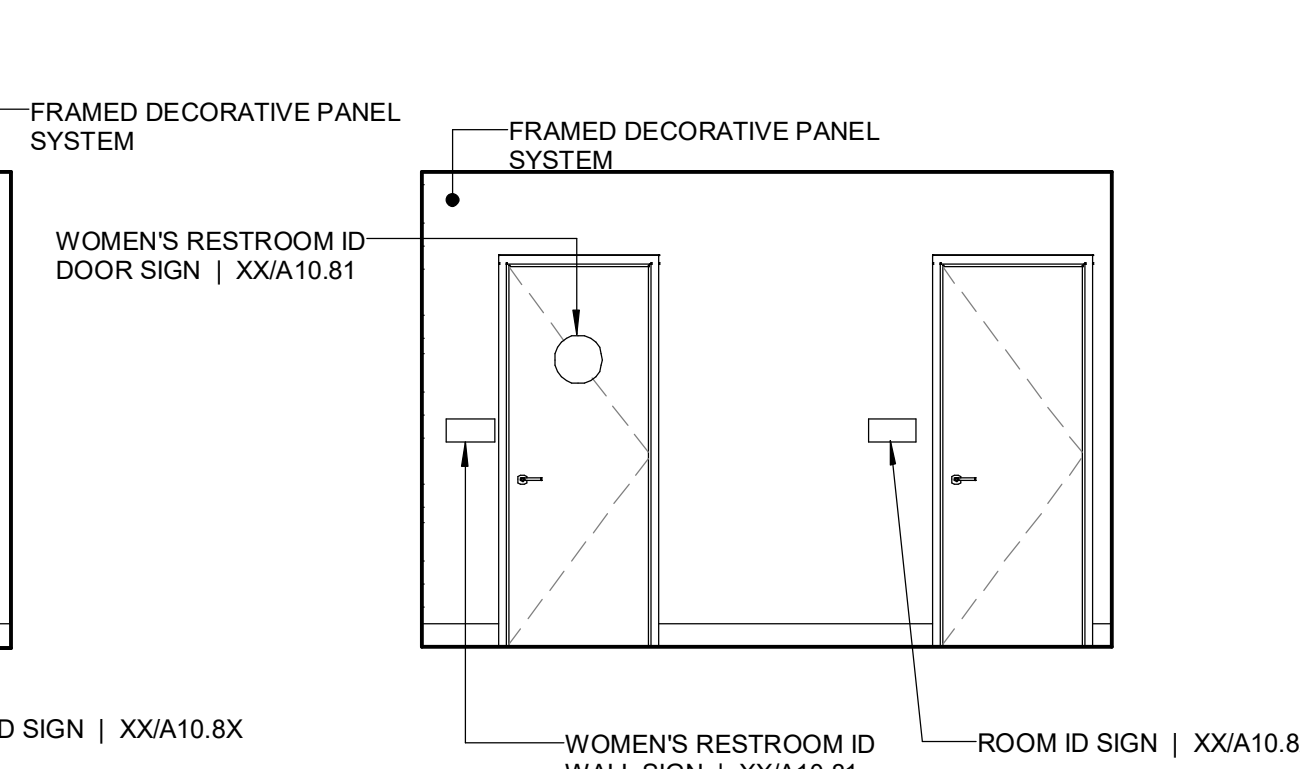


118 LOBBY 2 **3B**  
1/4" = 1'-0"

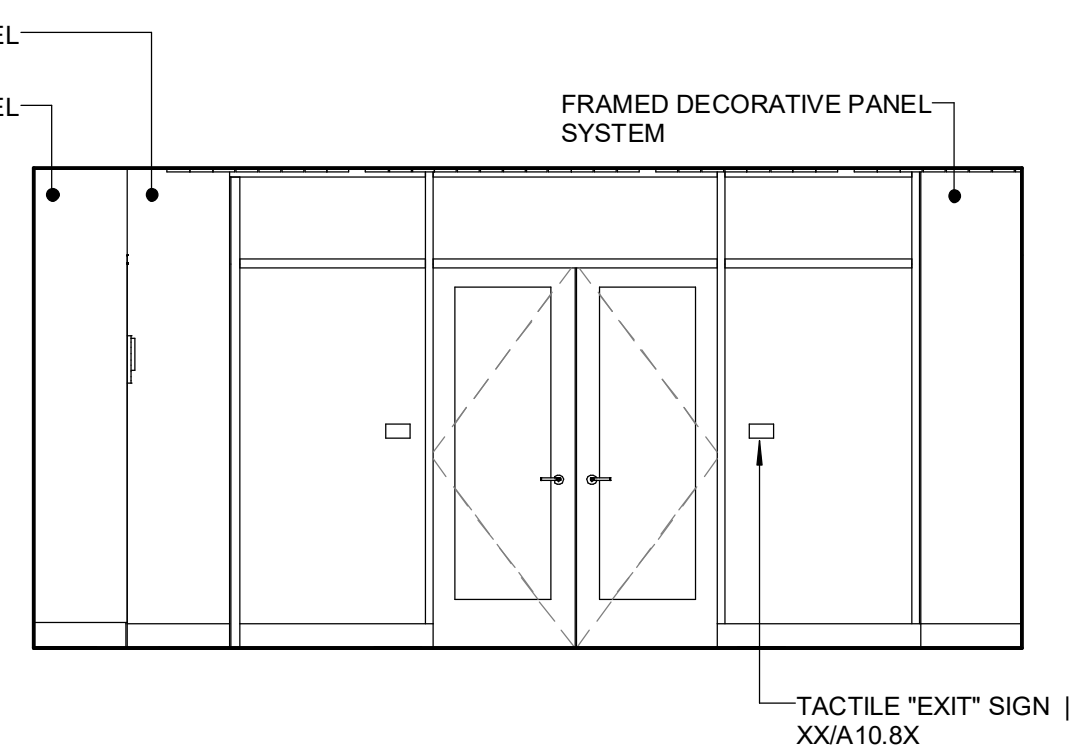


118 LOBBY 1 **3A**  
1/4" = 1'-0"

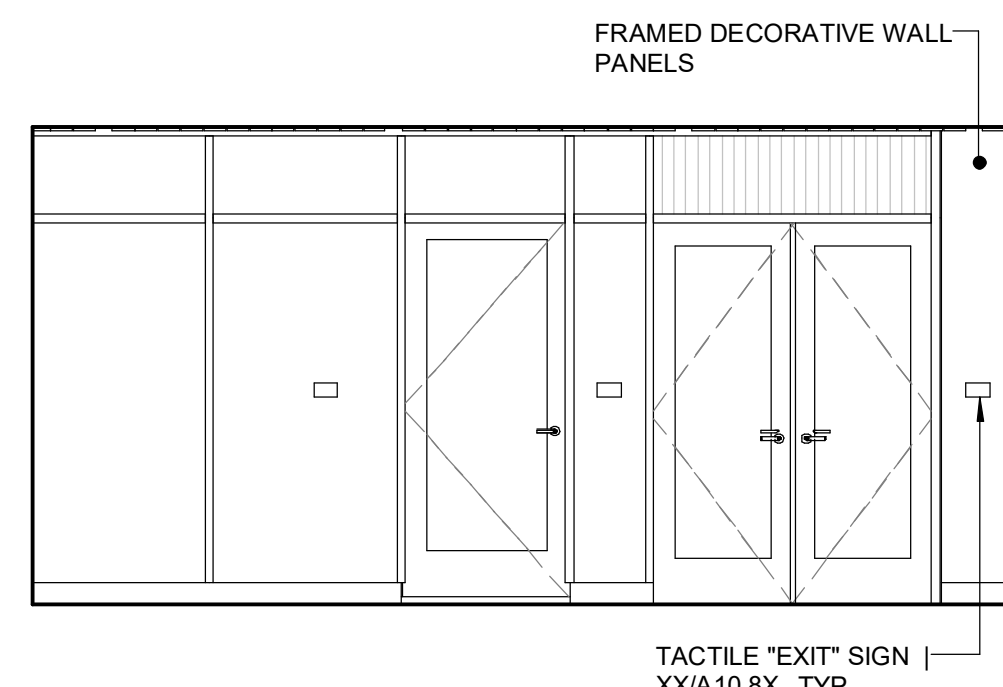


VESTIBULE 122 4 **6D**  
1/4" = 1'-0"

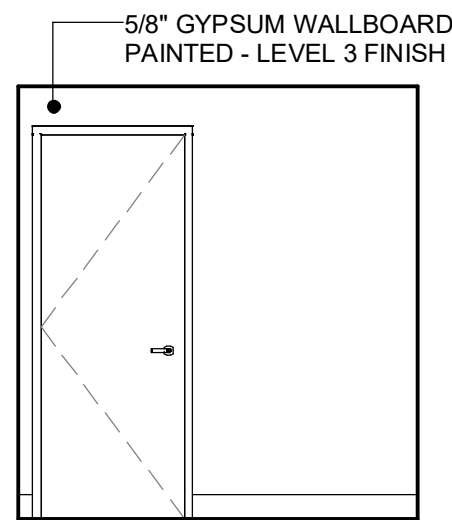


117 CUSTODIAL 4 **2D**  
1/4" = 1'-0"

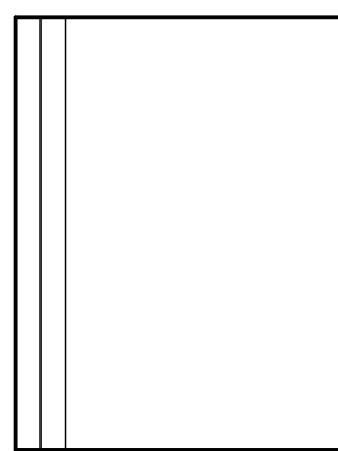


117 CUSTODIAL 3 **2C**  
1/4" = 1'-0"

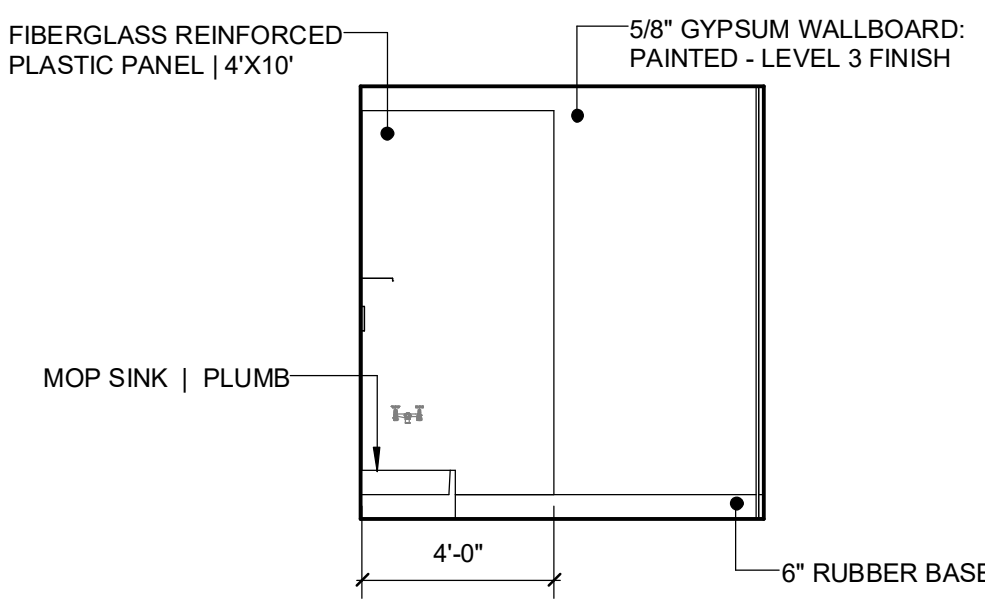


117 CUSTODIAL 2 **2B**  
1/4" = 1'-0"

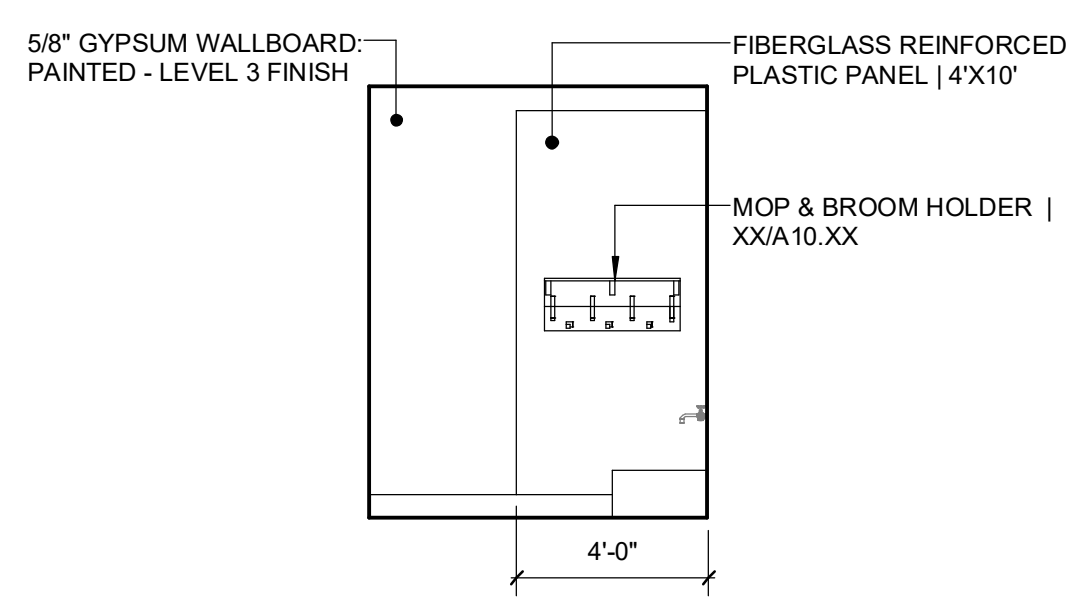


117 CUSTODIAL 1 **2A**  
1/4" = 1'-0"

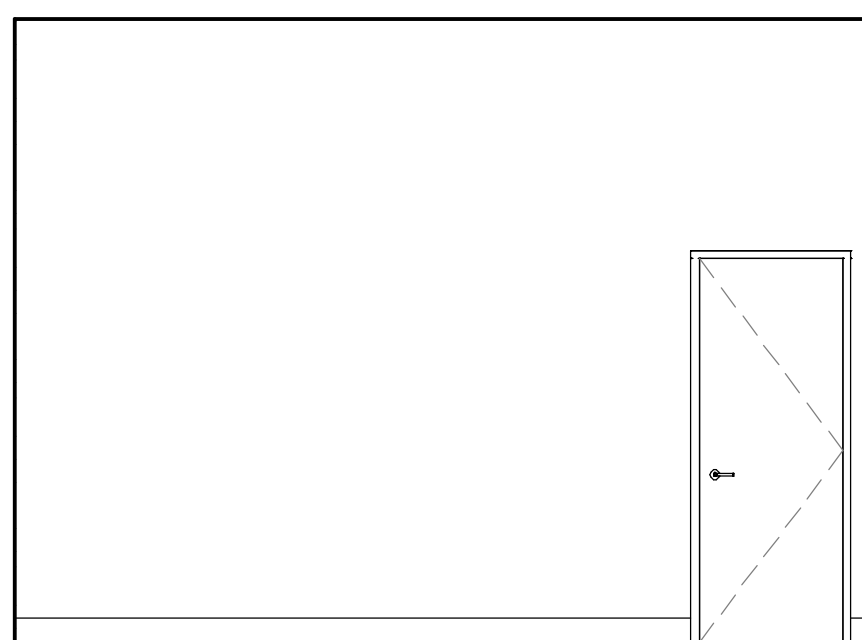


115 STORAGE 4 **1D**  
1/4" = 1'-0"

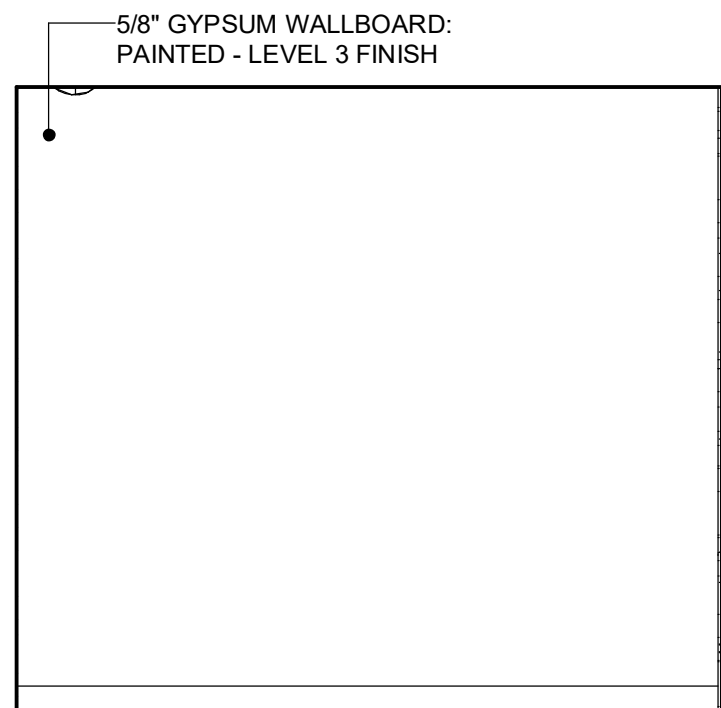

115 STORAGE 3 **1C**  
1/4" = 1'-0"

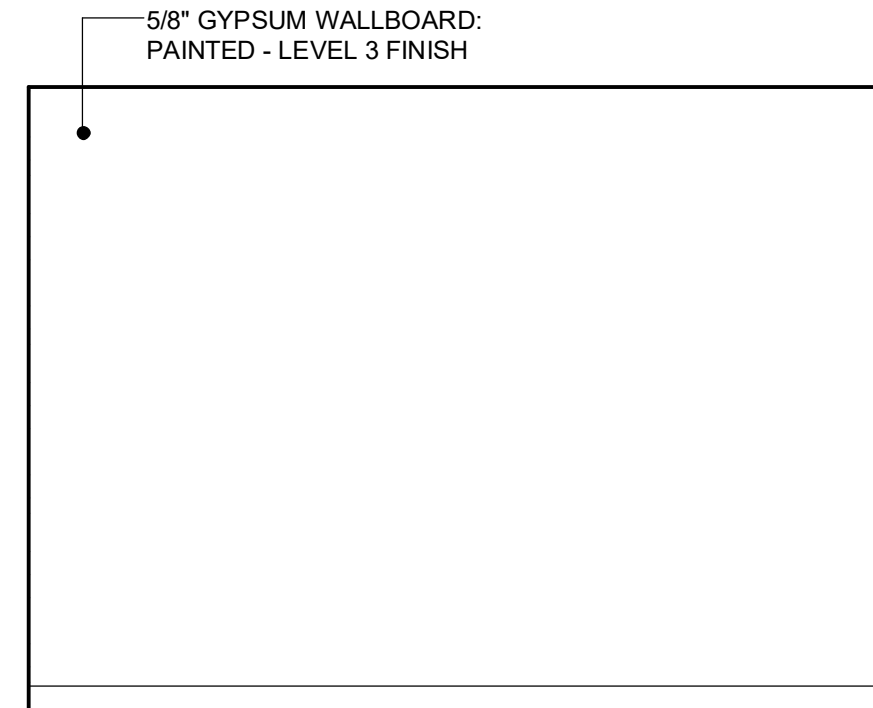

115 STORAGE 2 **1B**  
1/4" = 1'-0"

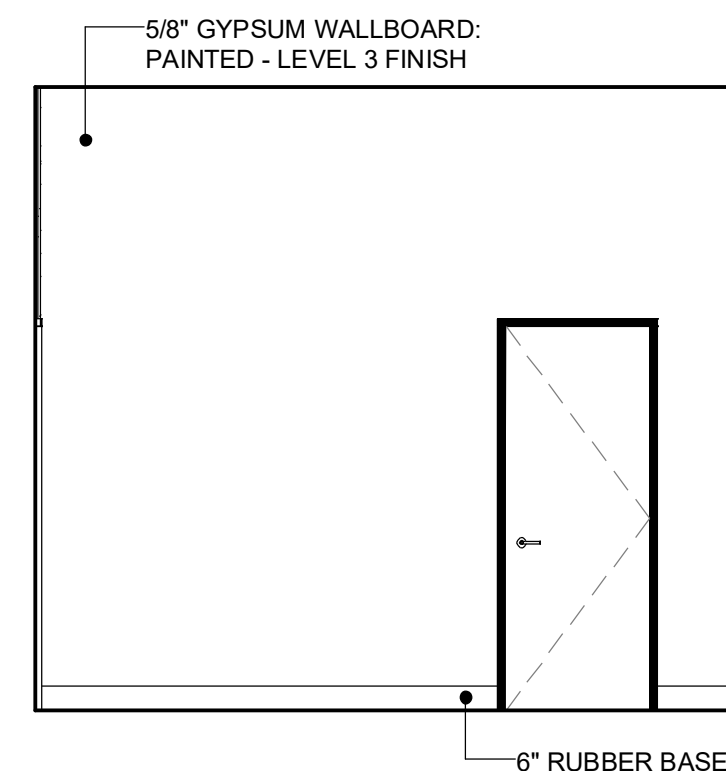

115 STORAGE 1 **1A**  
1/4" = 1'-0"



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PROJECT:  
**STOCKTON USD WEBER INSTITUTE GYMNASIUM**

SHEET NAME:  
**INTERIOR ELEVATIONS - BUILDING C**

**DESIGN DEVELOPMENT**



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CLIENT PROJ NO:

SHEET:


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DEMOLITION PLAN - BUILDING M 2  
1/8" = 1'-0"



IMPROVEMENT PLAN - BUILDING M 1  
1/8" = 1'-0"
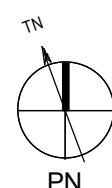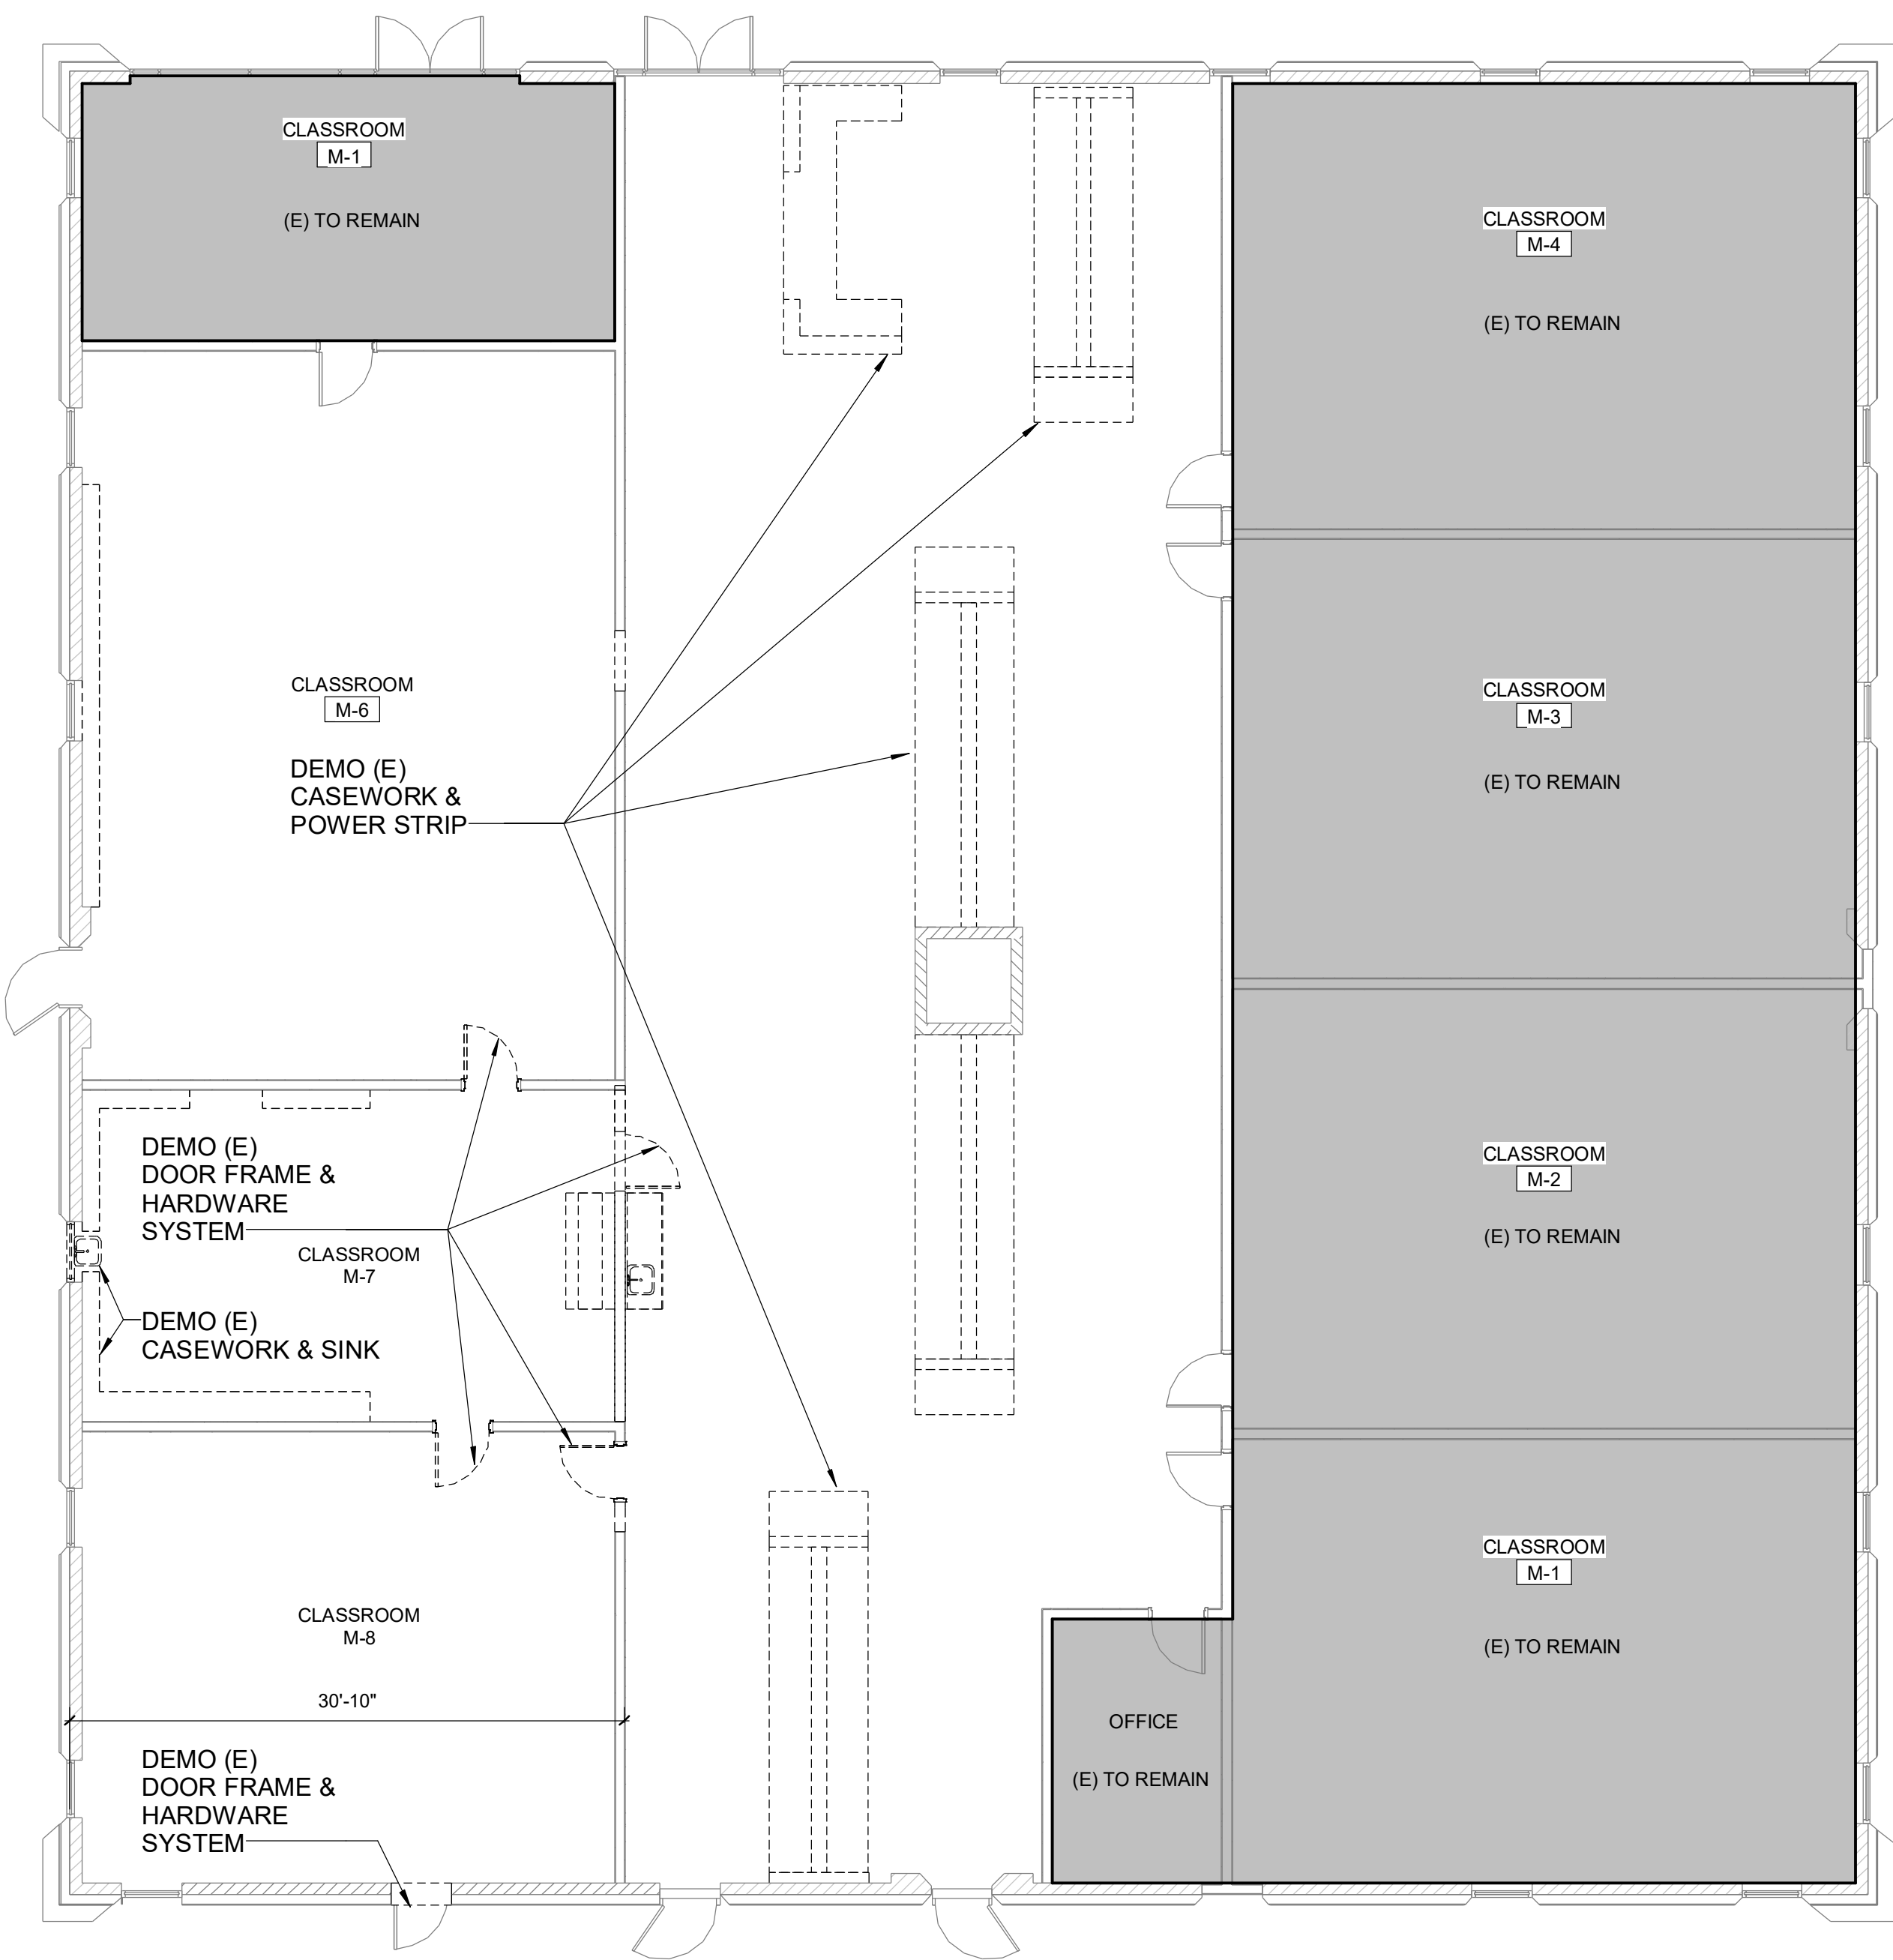
## LEGEND

	EXISTING ELEMENT TO REMAIN
	EXISTING ELEMENT TO BE DEMOLISHED
	NON-RATED PARTITION
	SMOKE BARRIER
	1 HR FIRE PARTITION
	1 HR FIRE BARRIER
	2 HR FIRE BARRIER
	3 HR FIRE BARRIER
	4 HR FIRE BARRIER
	TEMPORARY PARTITION

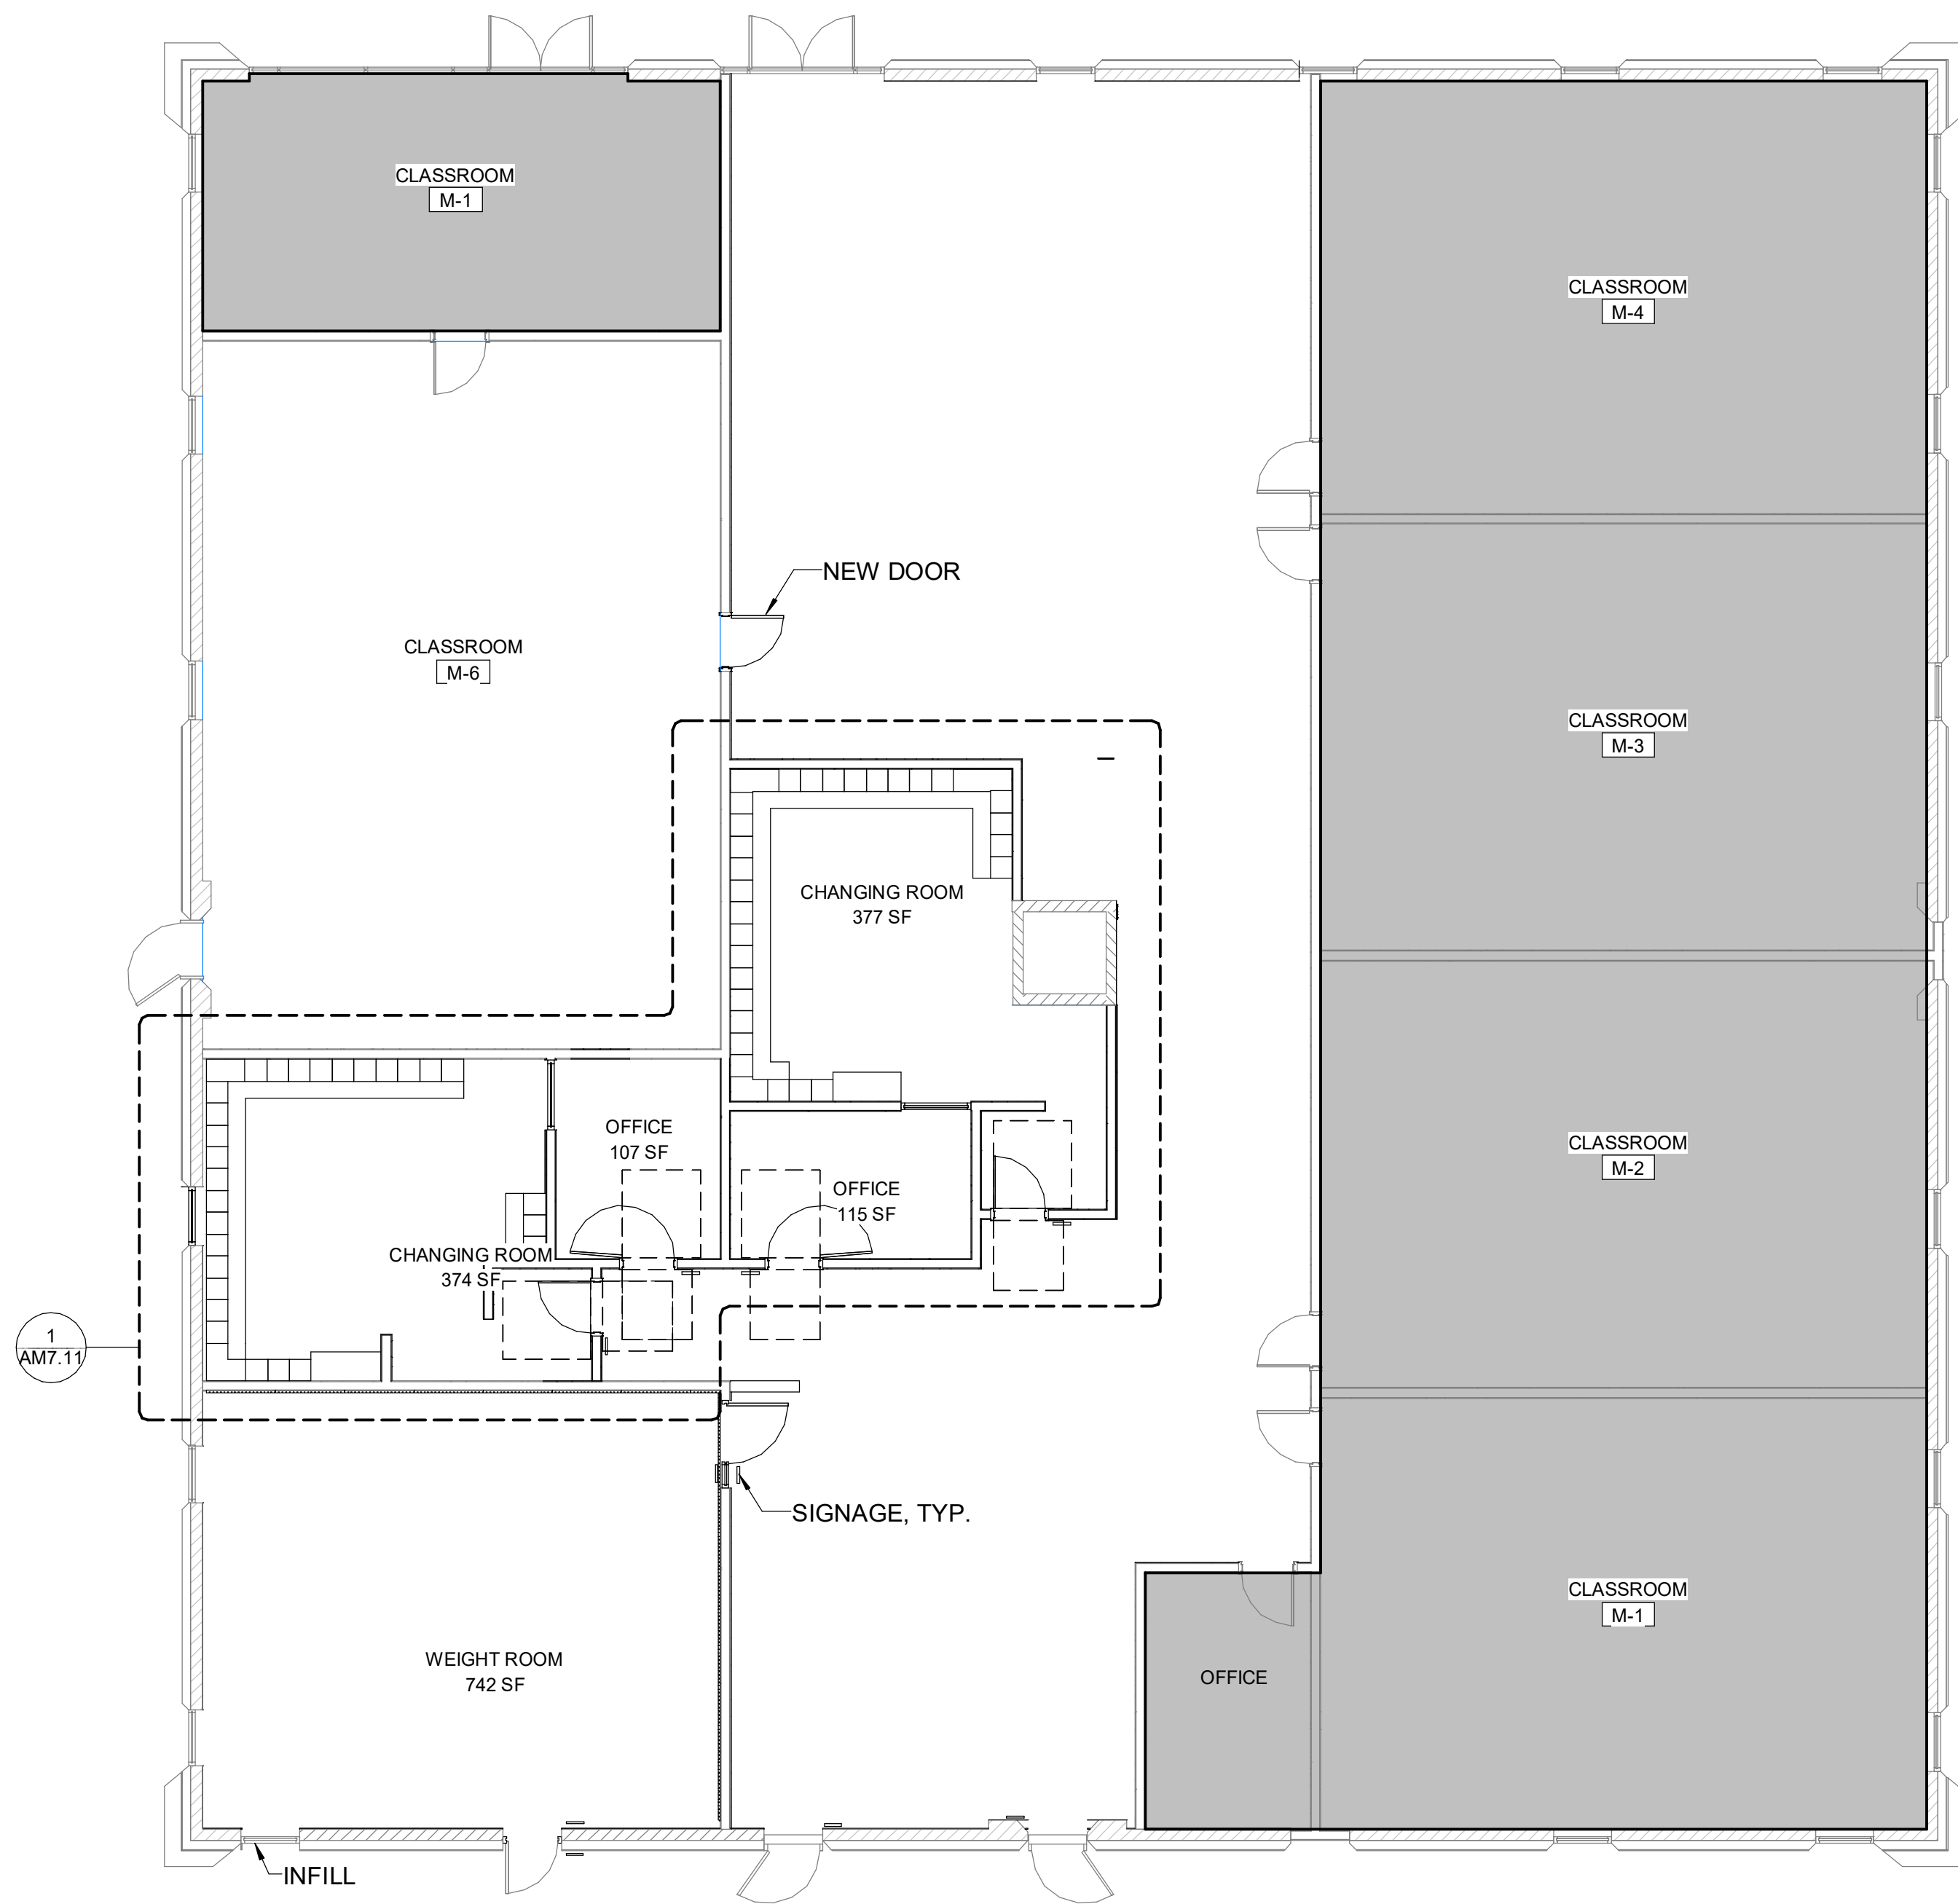

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## NOTES

- REFER TO SHEET G0.11 FOR TYPICAL SYMBOLS AND ABBREVIATIONS.
- REFER TO G-SERIES SHEETS FOR ADDITIONAL INFO AND CODE REQUIREMENTS.
- FOR ADDITIONAL ELEVATION CALLOUTS SEE ENLARGED PLANS.
- REFER TO PARTIAL PLANS FOR MORE INFORMATION. OVERALL PLANS ARE INTENDED TO PROVIDE CONTEXT FOR PARTIAL PLANS.

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SHEET NAME:  
BUILDING M - DEMOLITION & IMPROVEMENT PLAN


DESIGN DEVELOPMENT

DATE: 4/15/2025 CLIENT PROJ NO:

SHEET:


AM2.11



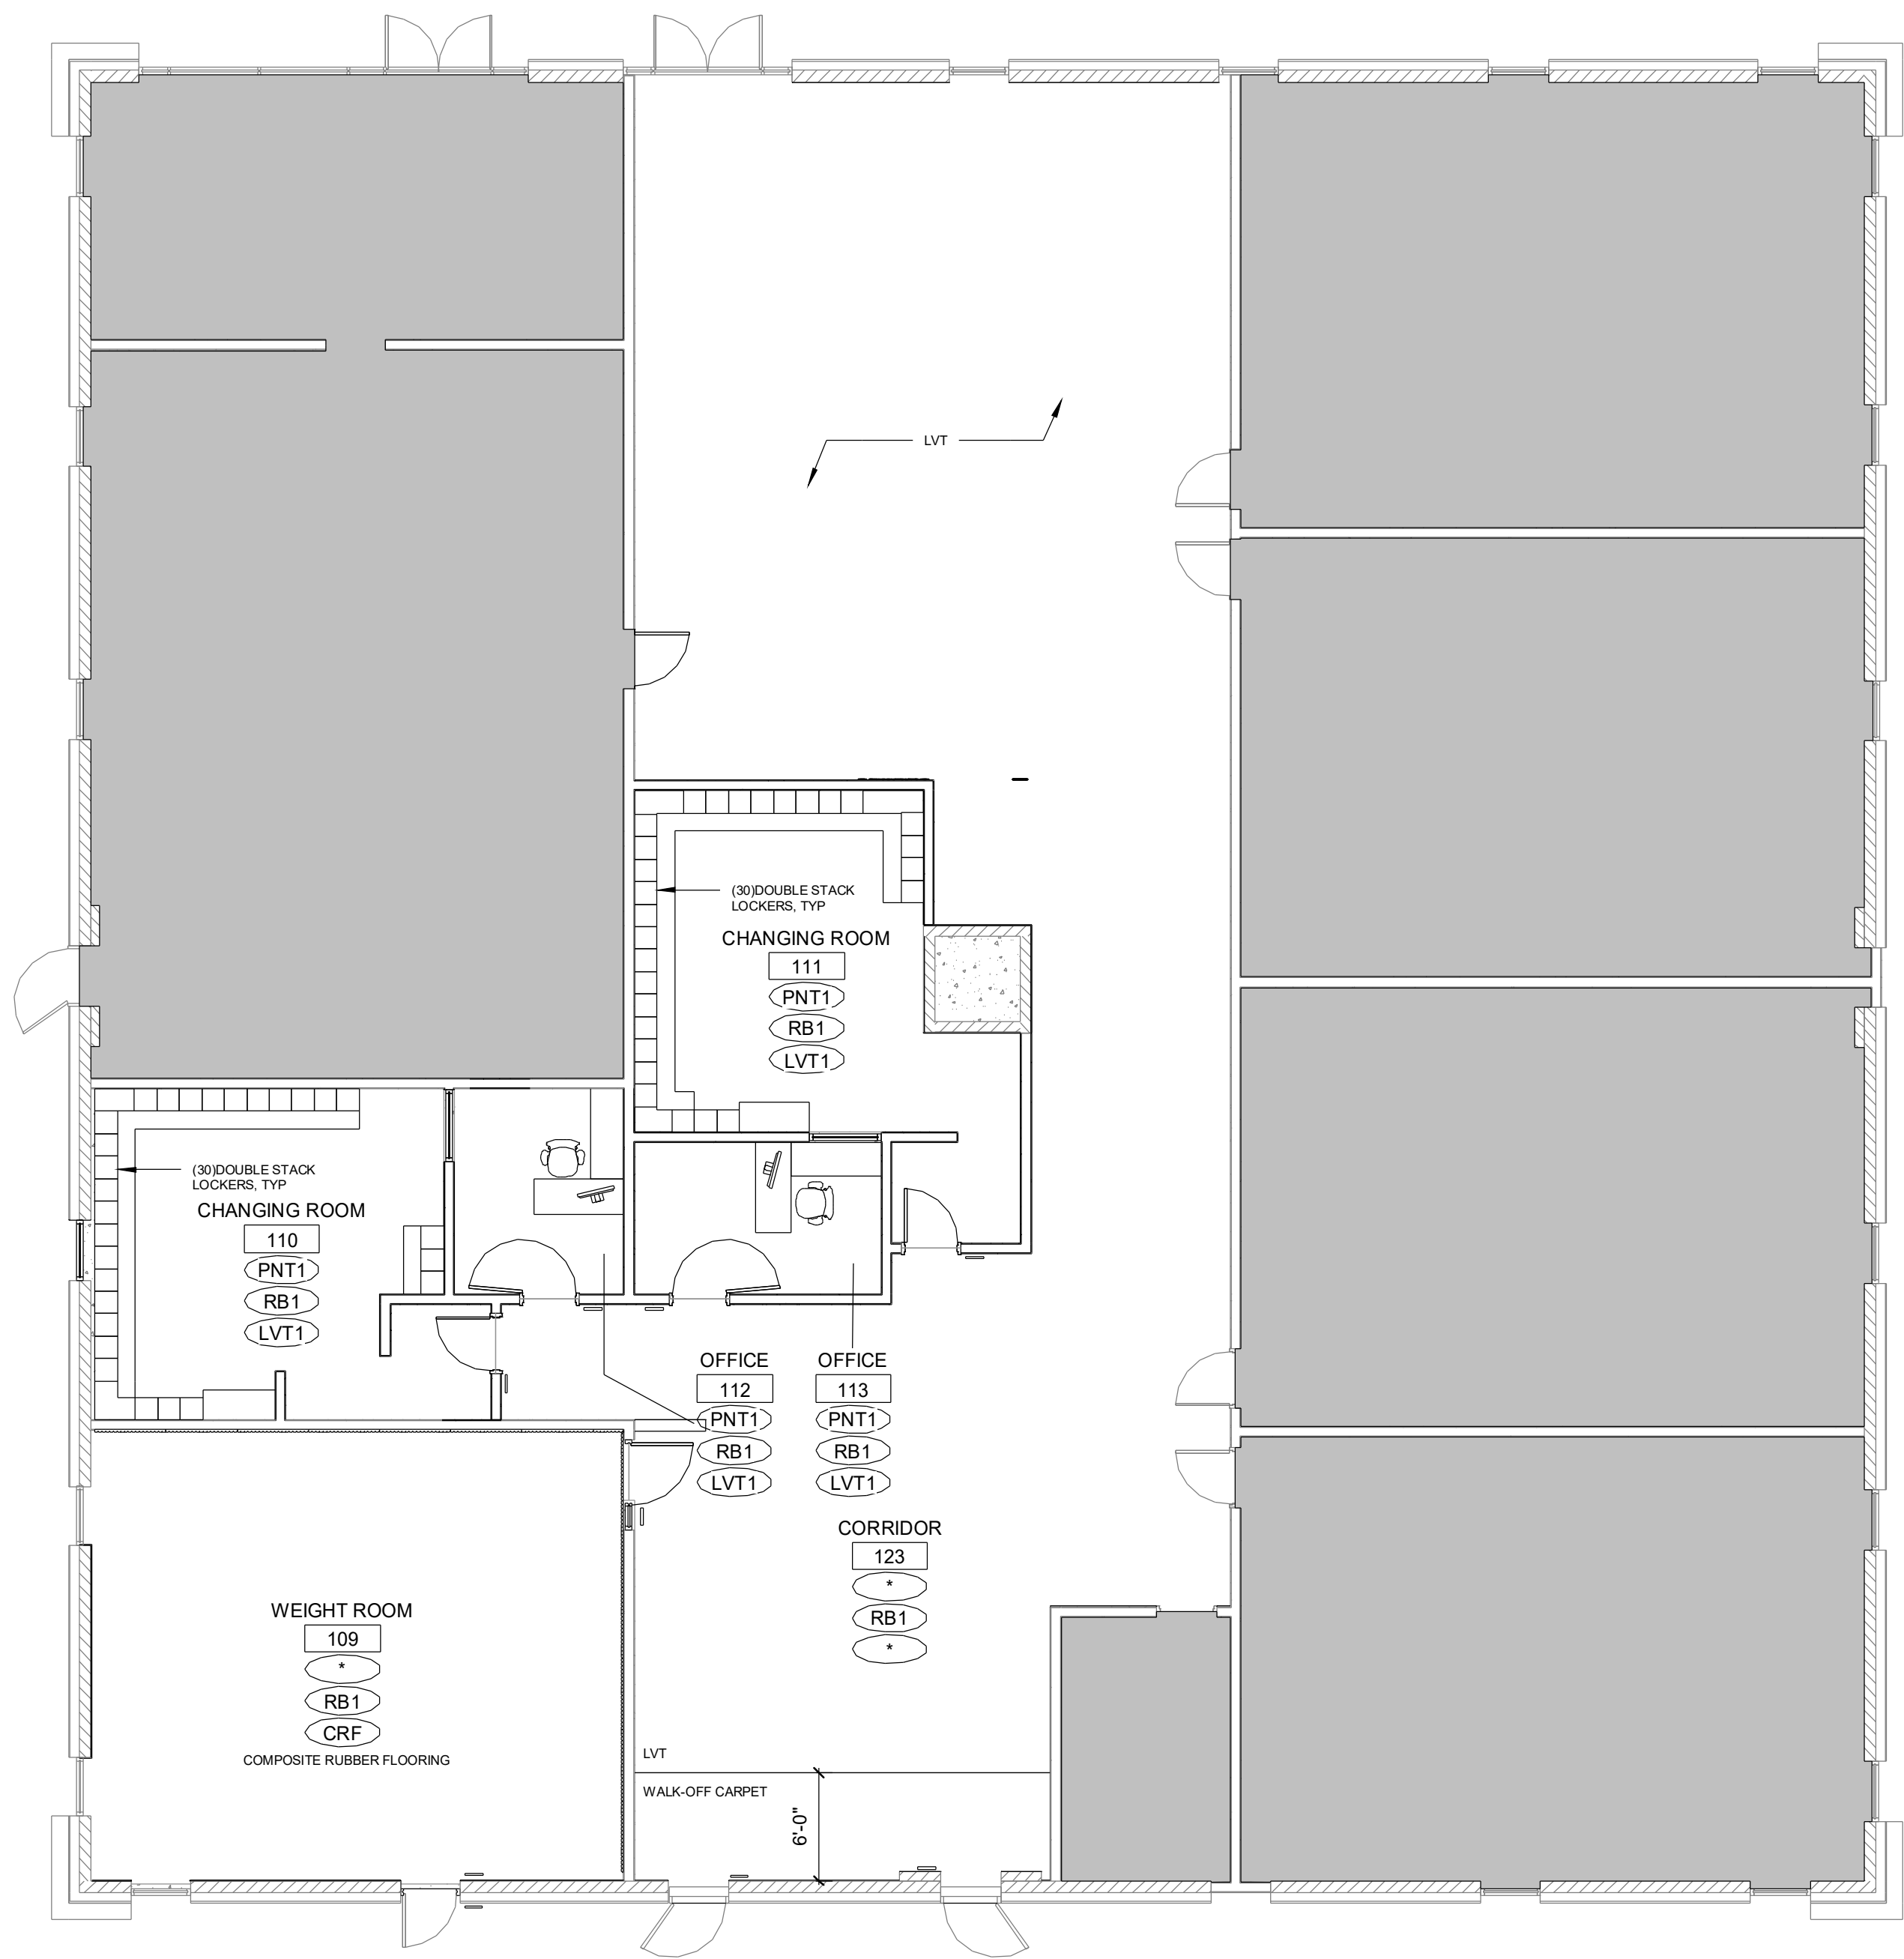

LEGEND

- Room Name
- ### ROOM FIELD WALL FINISH - SEE SCHEDULE
  - \* = MULTIPLE FINISHES, SEE INT ELEVATION
  - XX# WALL BASE FINISH, SEE FINISH SCHEDULE
  - XX# ROOM FLOORING FINISH, SEE FINISH SCHEDULE
- FINISHES NOTED ABOVE ARE TYPICAL FIELD FINISHES FOR THE ROOM, U.N.O. ADDITIONAL FINISHES MAYH BE INDICATED ON THIS PLAN AND/OR INTERIOR ELEVATIONS.
- FA FINISH/COLOR - SEE FINISH SCHEDULE
  - ↗ DENOTES DIRECTION OF FLOORING - IF APPLICABLE

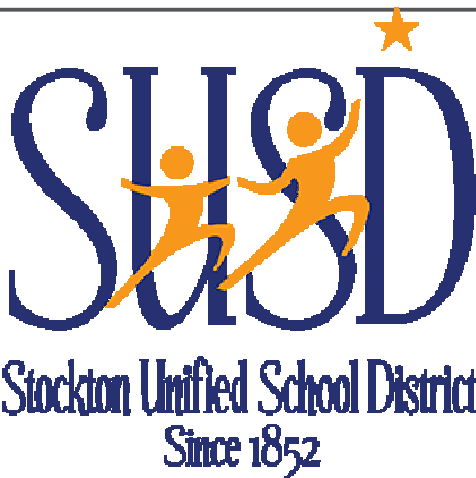

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SHEET NAME:  
BUILDING M - FINISH PLAN

DESIGN DEVELOPMENT

DATE: 4/15/2025	CLIENT PROJ NO:
SHEET:	

BUILDING M - FINISH PLAN

1


1/8" = 1'-0"

PLEASE RECYCLE

AM2.12

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ALL LINES SHOWN AND VISIBLE  
EXCEPT WHERE NOTED OTHERWISE  
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BUILDING M - DEMOLITION REFLECTED  
CEILING PLAN 2  
1/8" = 1'-0"

## LEGEND- RCP'S

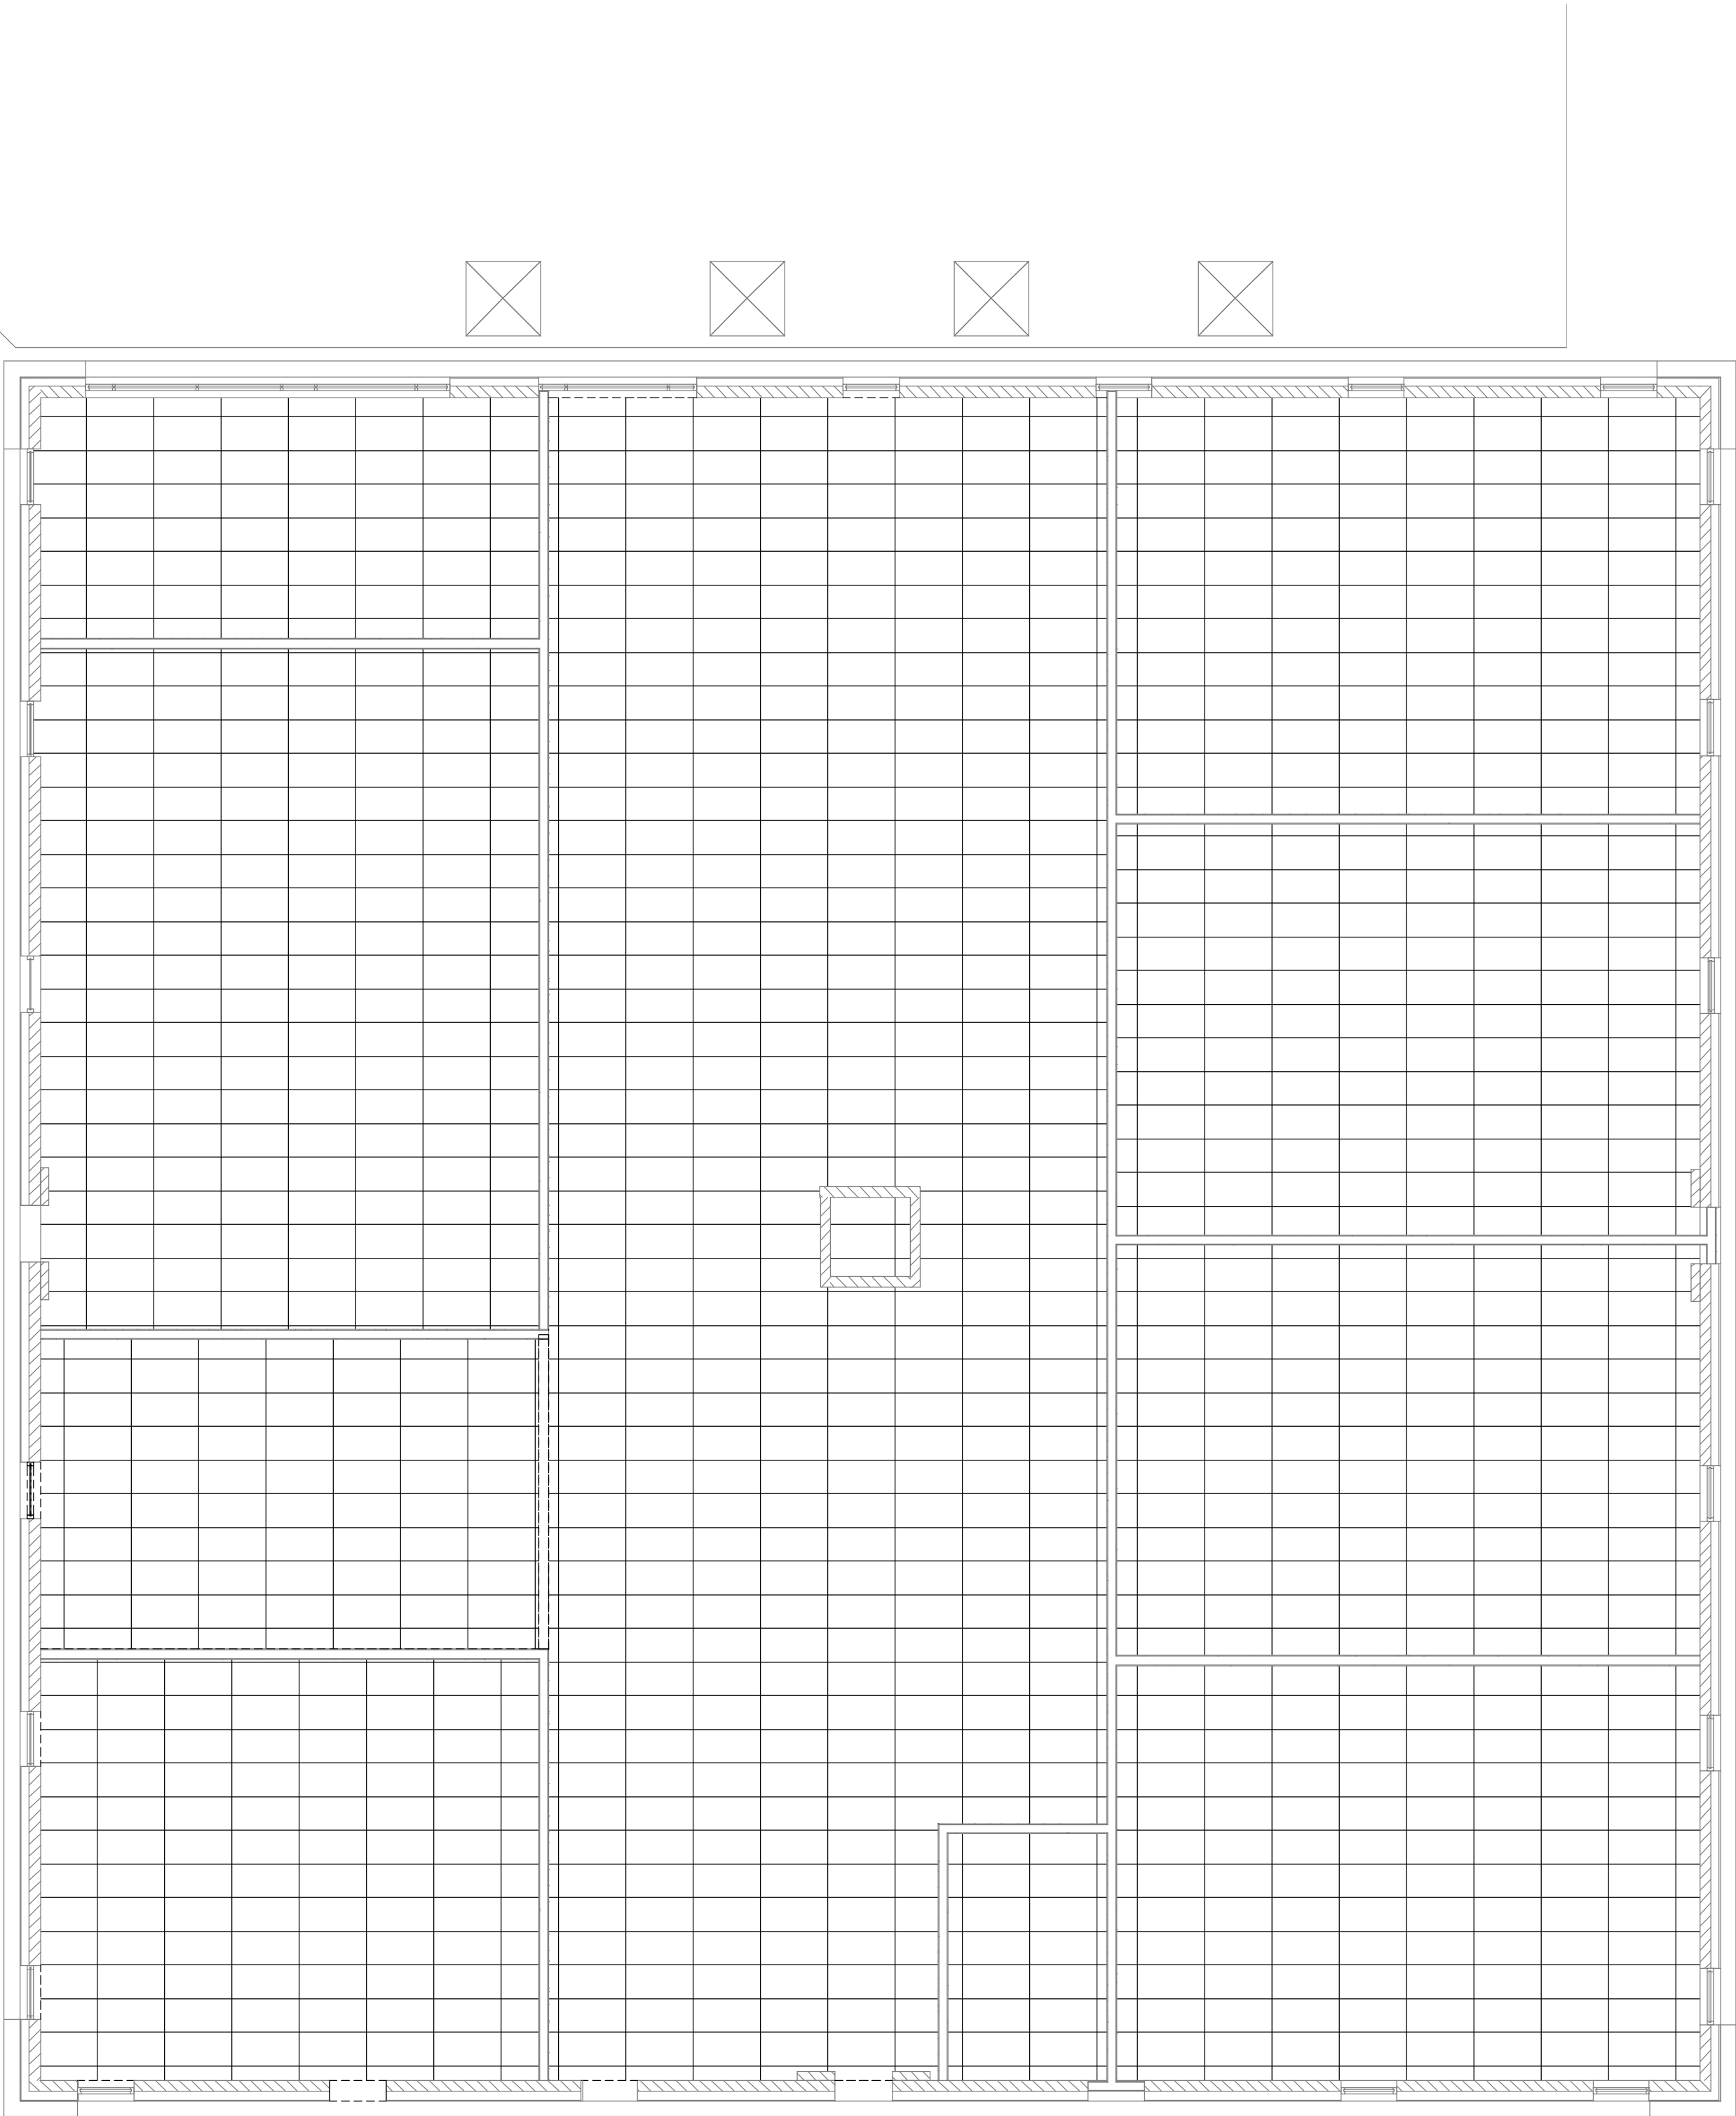
**BUILDING ELEMENTS**  
— EXISTING PARTITION TO REMAIN  
- - - - - TEMPORARY PARTITION  
= = = = = PARTITION

GB, PLASTER, OR  
STUCCO CEILING-  
REF: CEILING TAGS  
24"x24" ACOUSTIC TILE  
CEILING SYSTEM- REF:  
CEILING TAGS AND  
SPECIFICATIONS  
24"x48" ACOUSTIC  
TILE CEILING  
SYSTEM- REF:  
CEILING TAGS AND  
SPECIFICATIONS  
24"x48" DIRECT  
ATTACH WOOD  
FIBER ACOUSTIC  
PANEL- REF: CEILING  
TAGS AND  
SPECIFICATIONS

CEILING TYPE  
HEIGHT ABOVE  
LEVEL (NOT FINISH  
FLOOR)  
GB21 10'-0"  
PT1  
10.000  
MATERIAL FINISH  
RETURN AIR GRILLE (DIAGONAL  
HATCH- SYMBOL SHAPES WILL  
VARY)  
SUPPLY AIR GRILLE  
(CROSSHATCH- SYMBOL SHAPES  
WILL VARY)  
LIGHT FIXTURE (SHADED- SYMBOL  
SHAPES WILL VARY)

## GENERAL NOTES- PARTIAL RCP'S

1. DIMENSIONS TO FACE OF PARTITIONS ARE TO FACE OF SUBSTRATE LAYER AS SHOWN IN PARTITION TYPES ON A0.11. FINISHES DEPICTED IN FINISH PLANS AND ELEVATIONS ARE NOT SHOWN ON PARTIAL FLOOR PLANS. REFER TO ENLARGED PLANS, ELEVATIONS, AND DETAILS.
- 2.

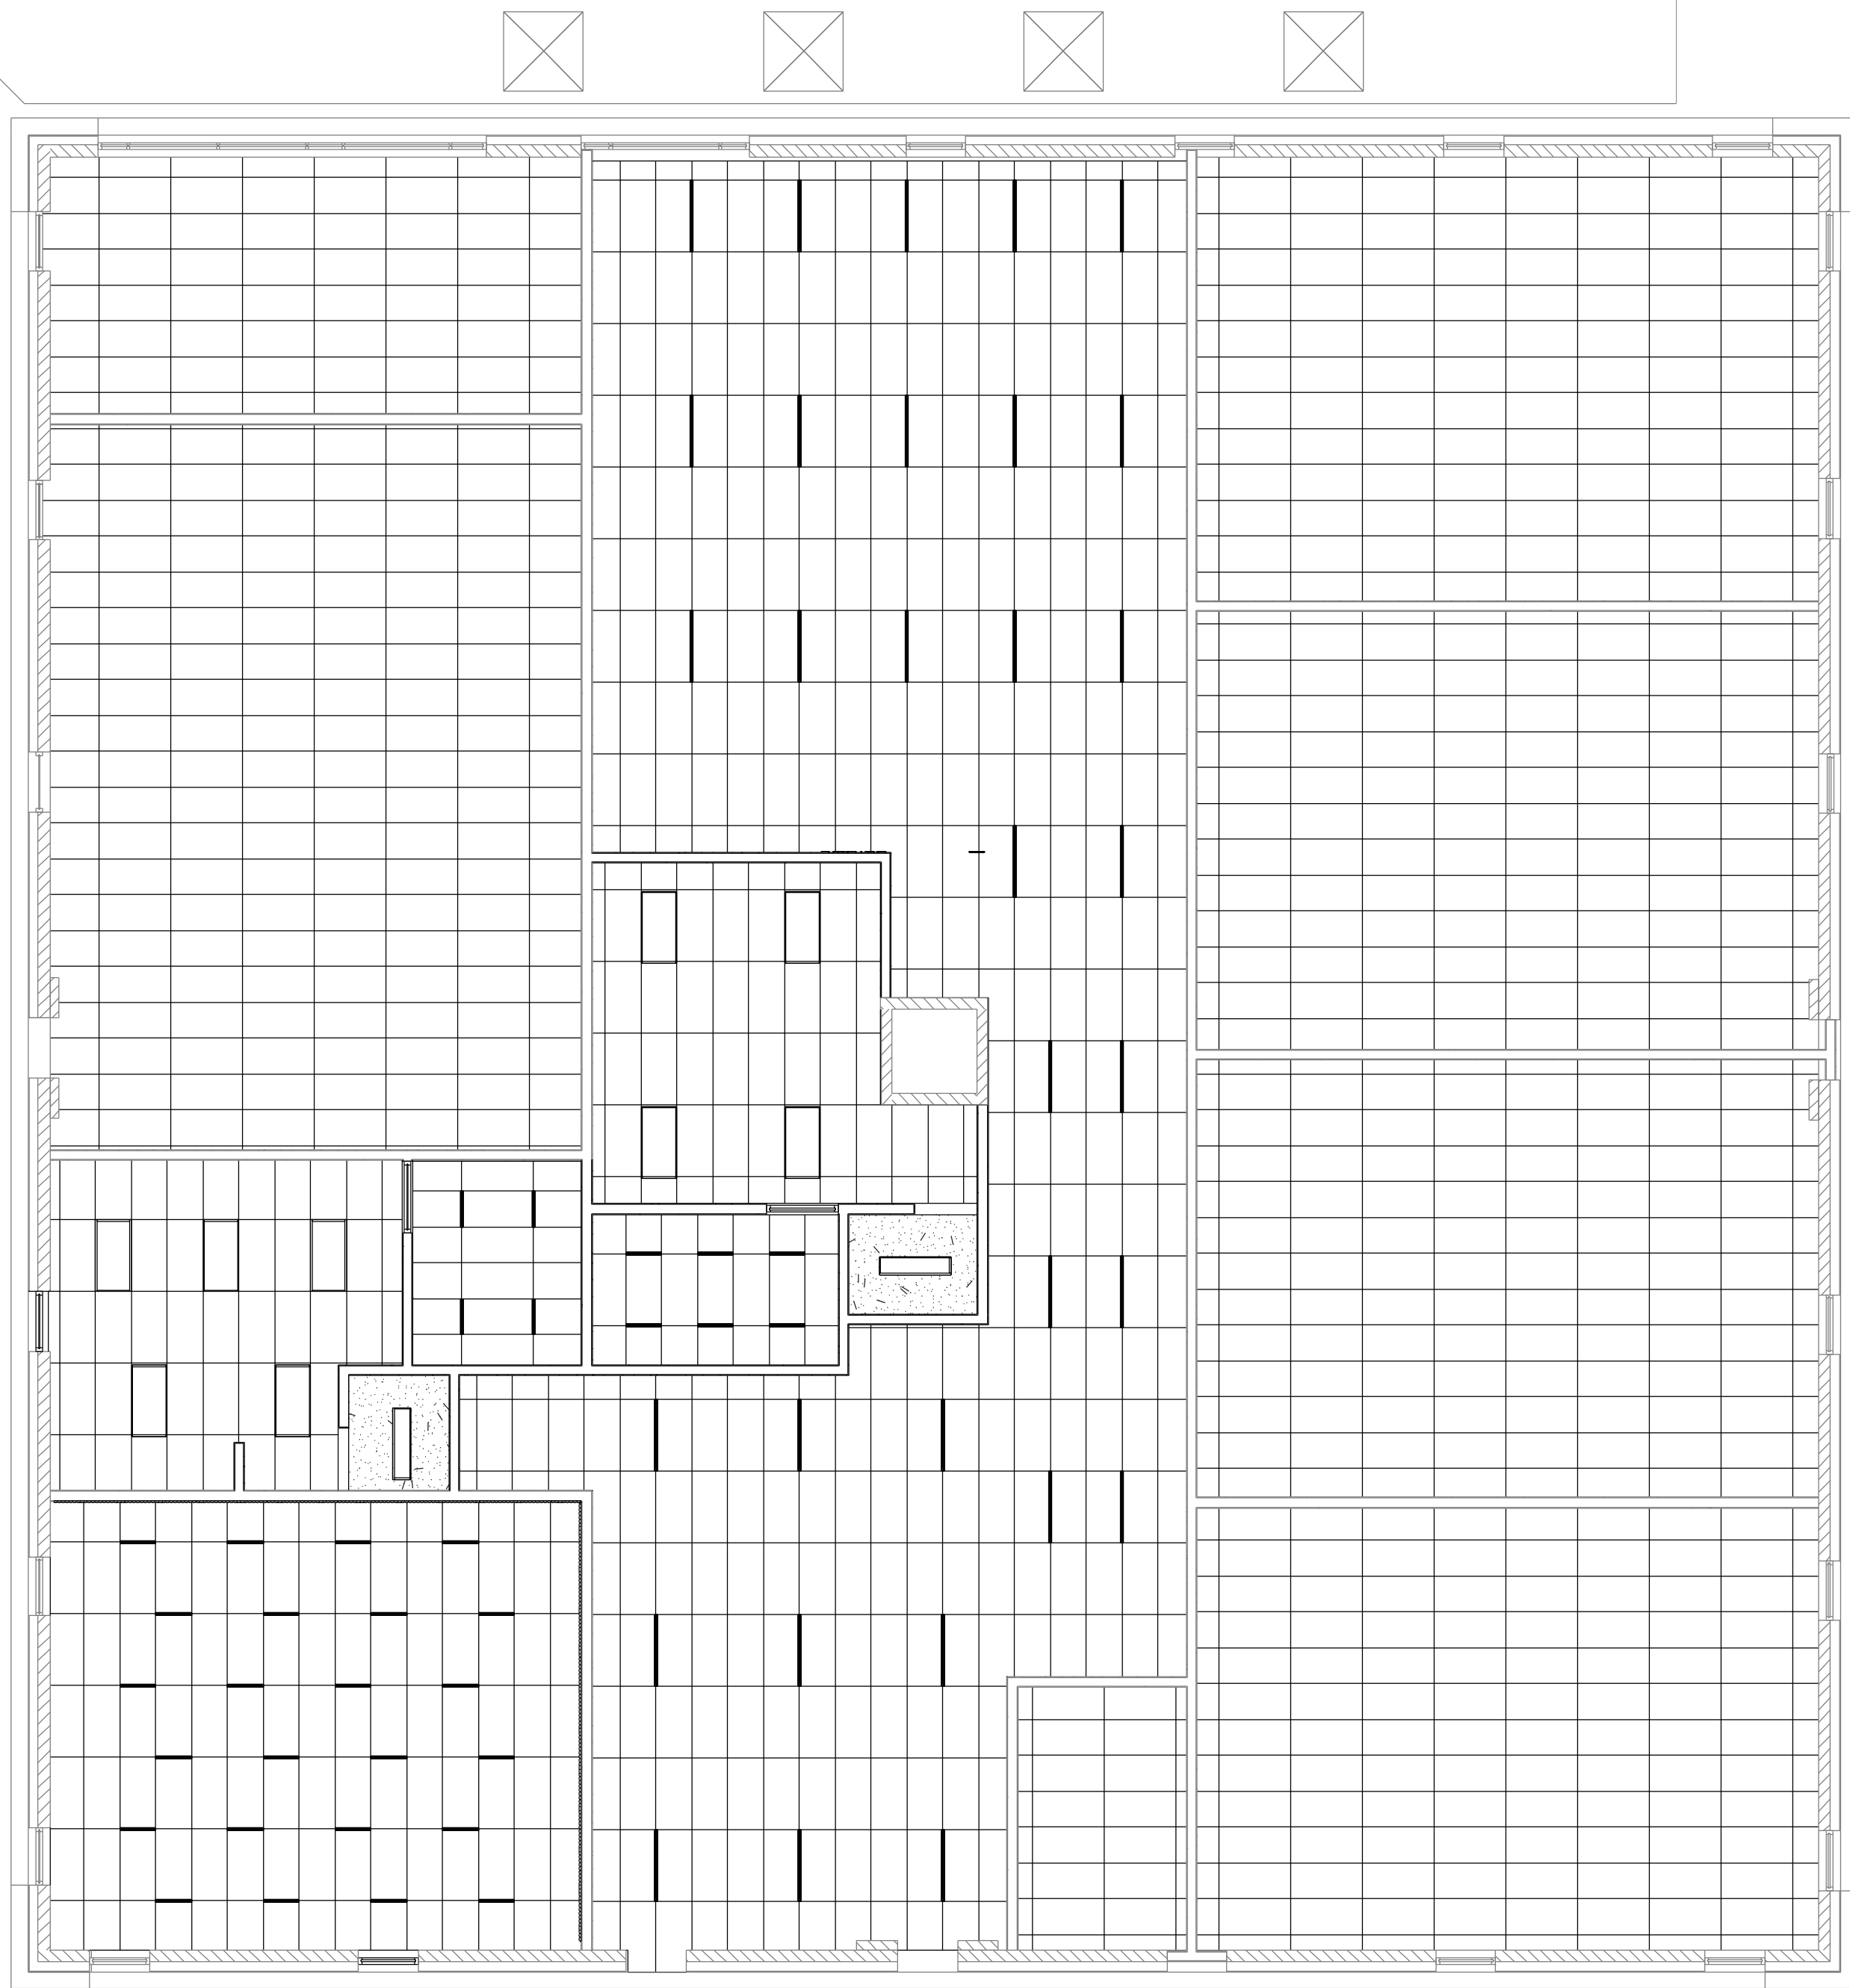

BUILDING M - IMPROVEMENT REFLECTED  
CEILING PLAN 1  
1/8" = 1'-0"



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## NOTES

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SHEET NAME:  
**BUILDING M - DEMOLITION & IMPROVEMENT  
REFLECTED CEILING PLAN**

**DESIGN DEVELOPMENT**

DATE: 4/15/2025  
CLIENT PROJ NO:

SHEET:


**AM3.11**

PLEASE RECYCLE




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FOOTING IS THE ORIGINAL  
SHEET'S ORIGINAL PAGE SIZE

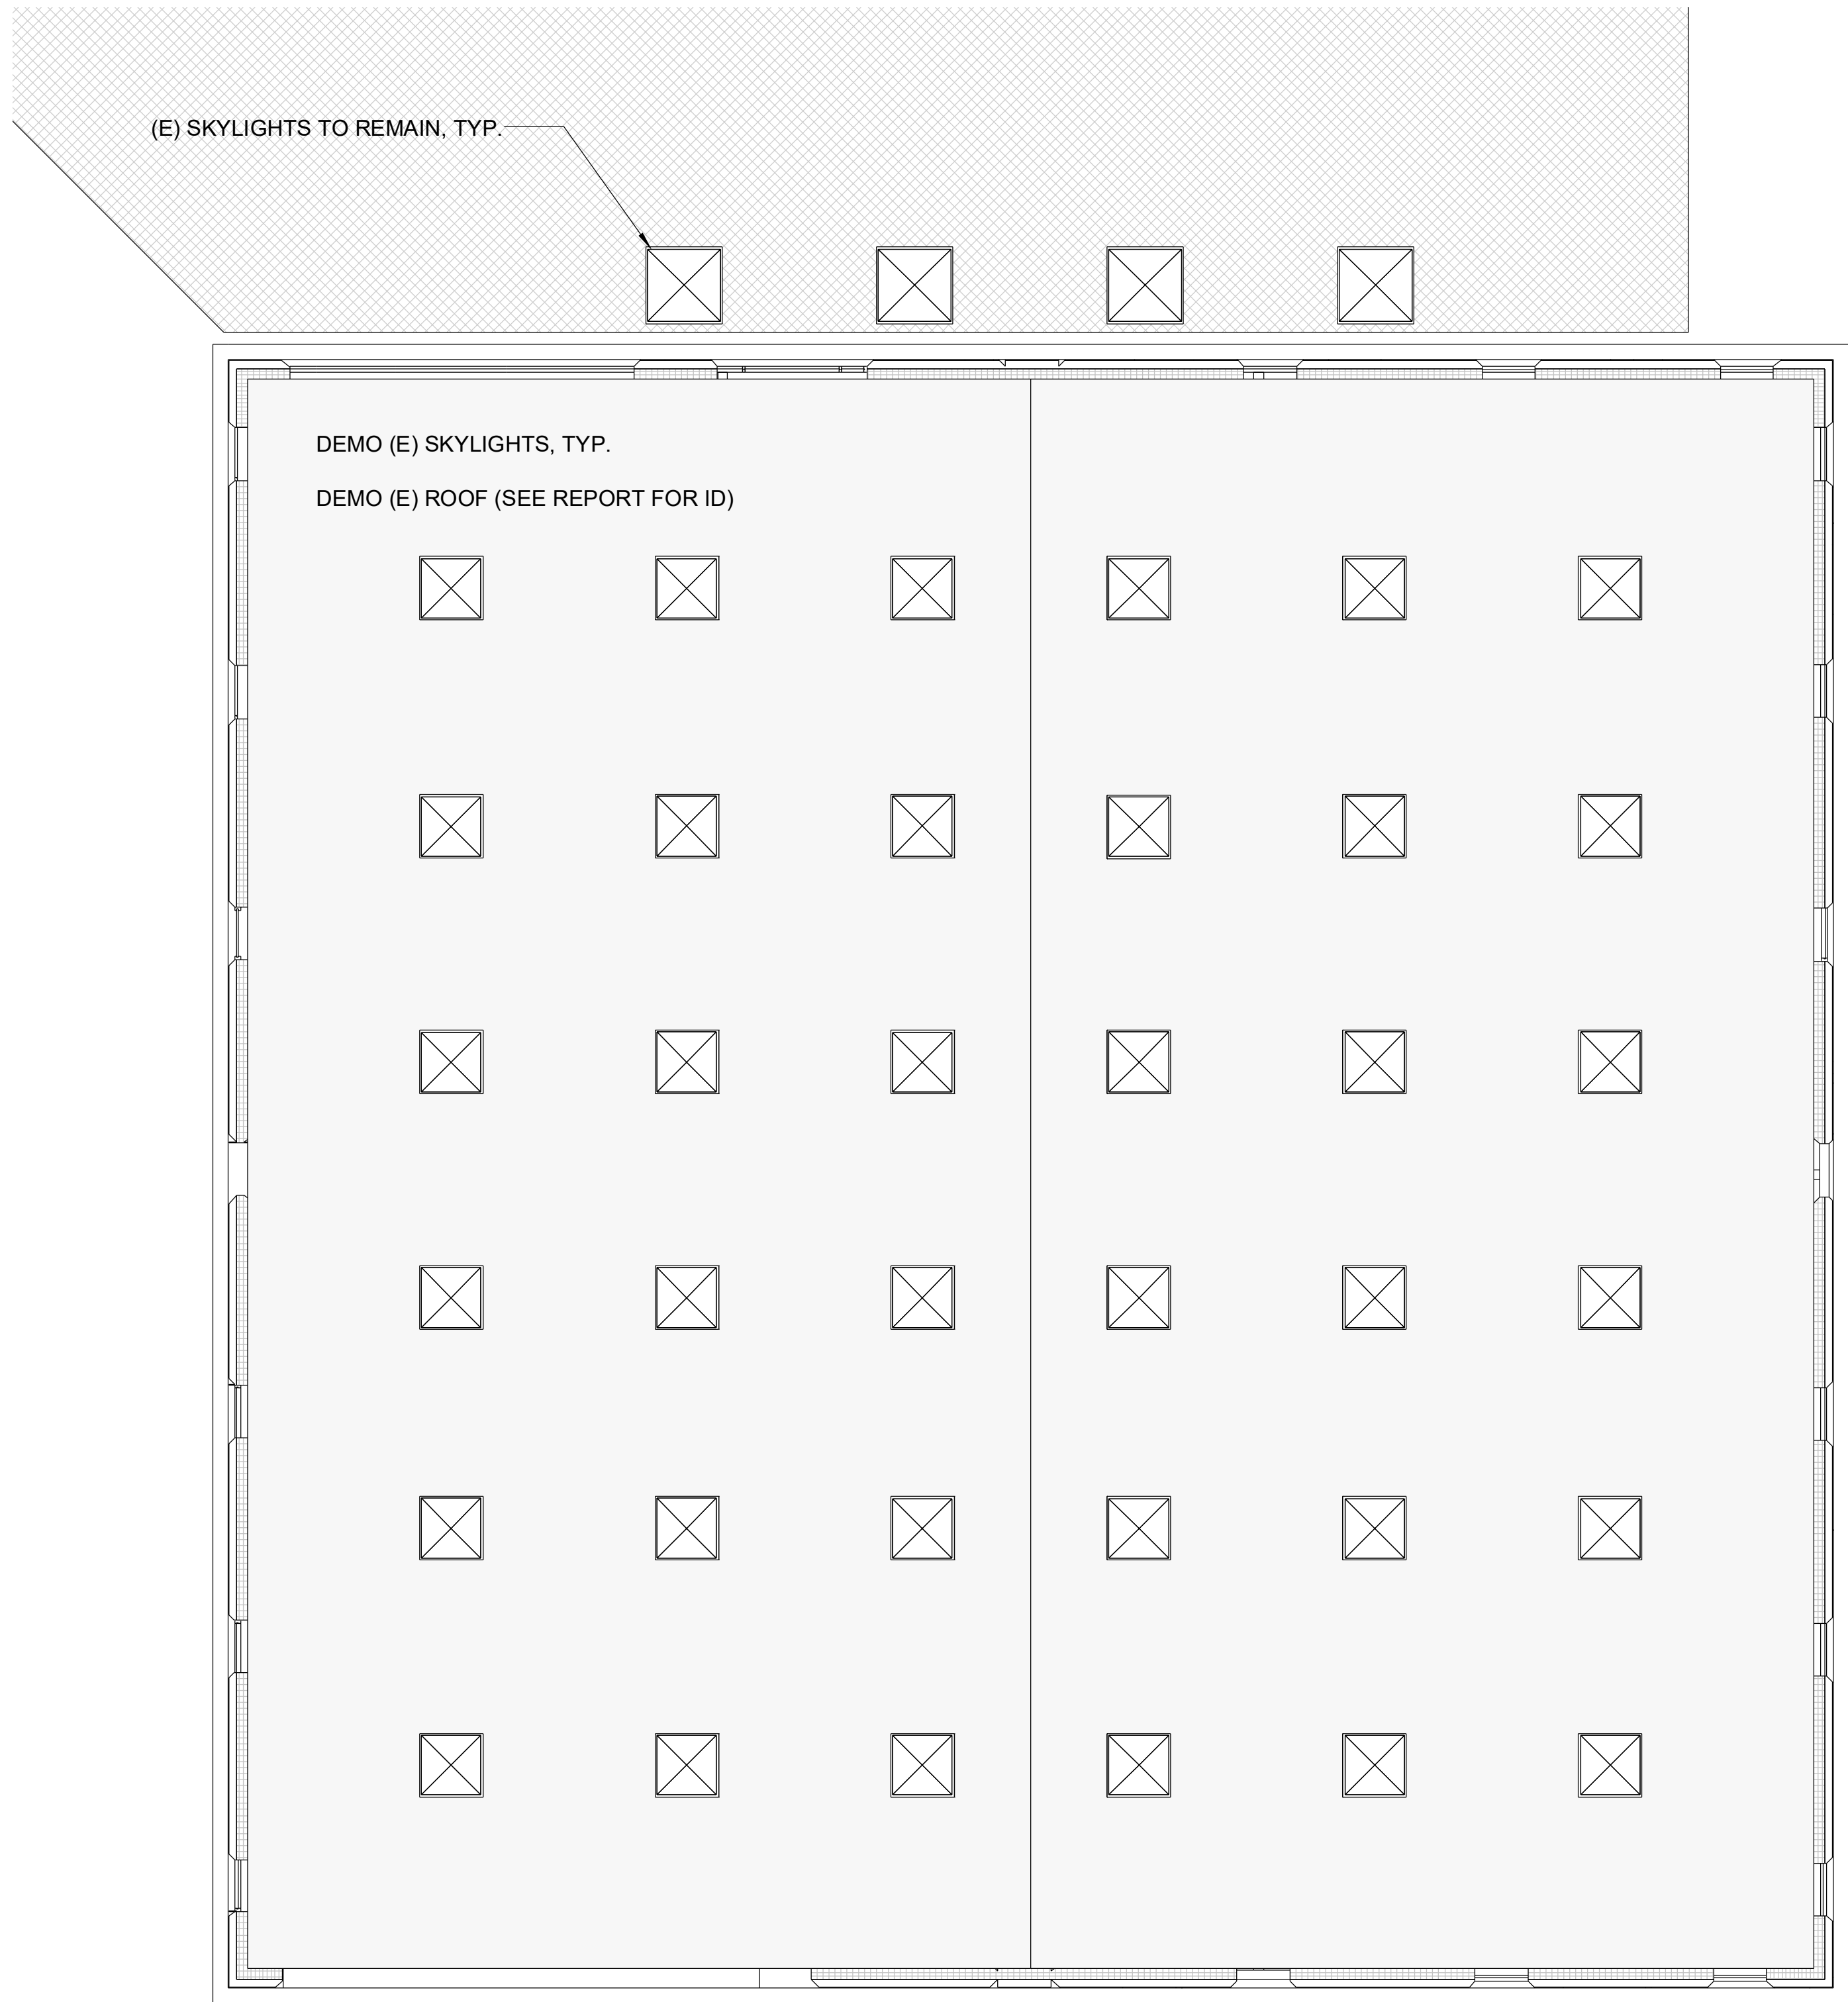

BUILDING M - DEMOLITION ROOF PLAN **2**  
1/8" = 1'-0"

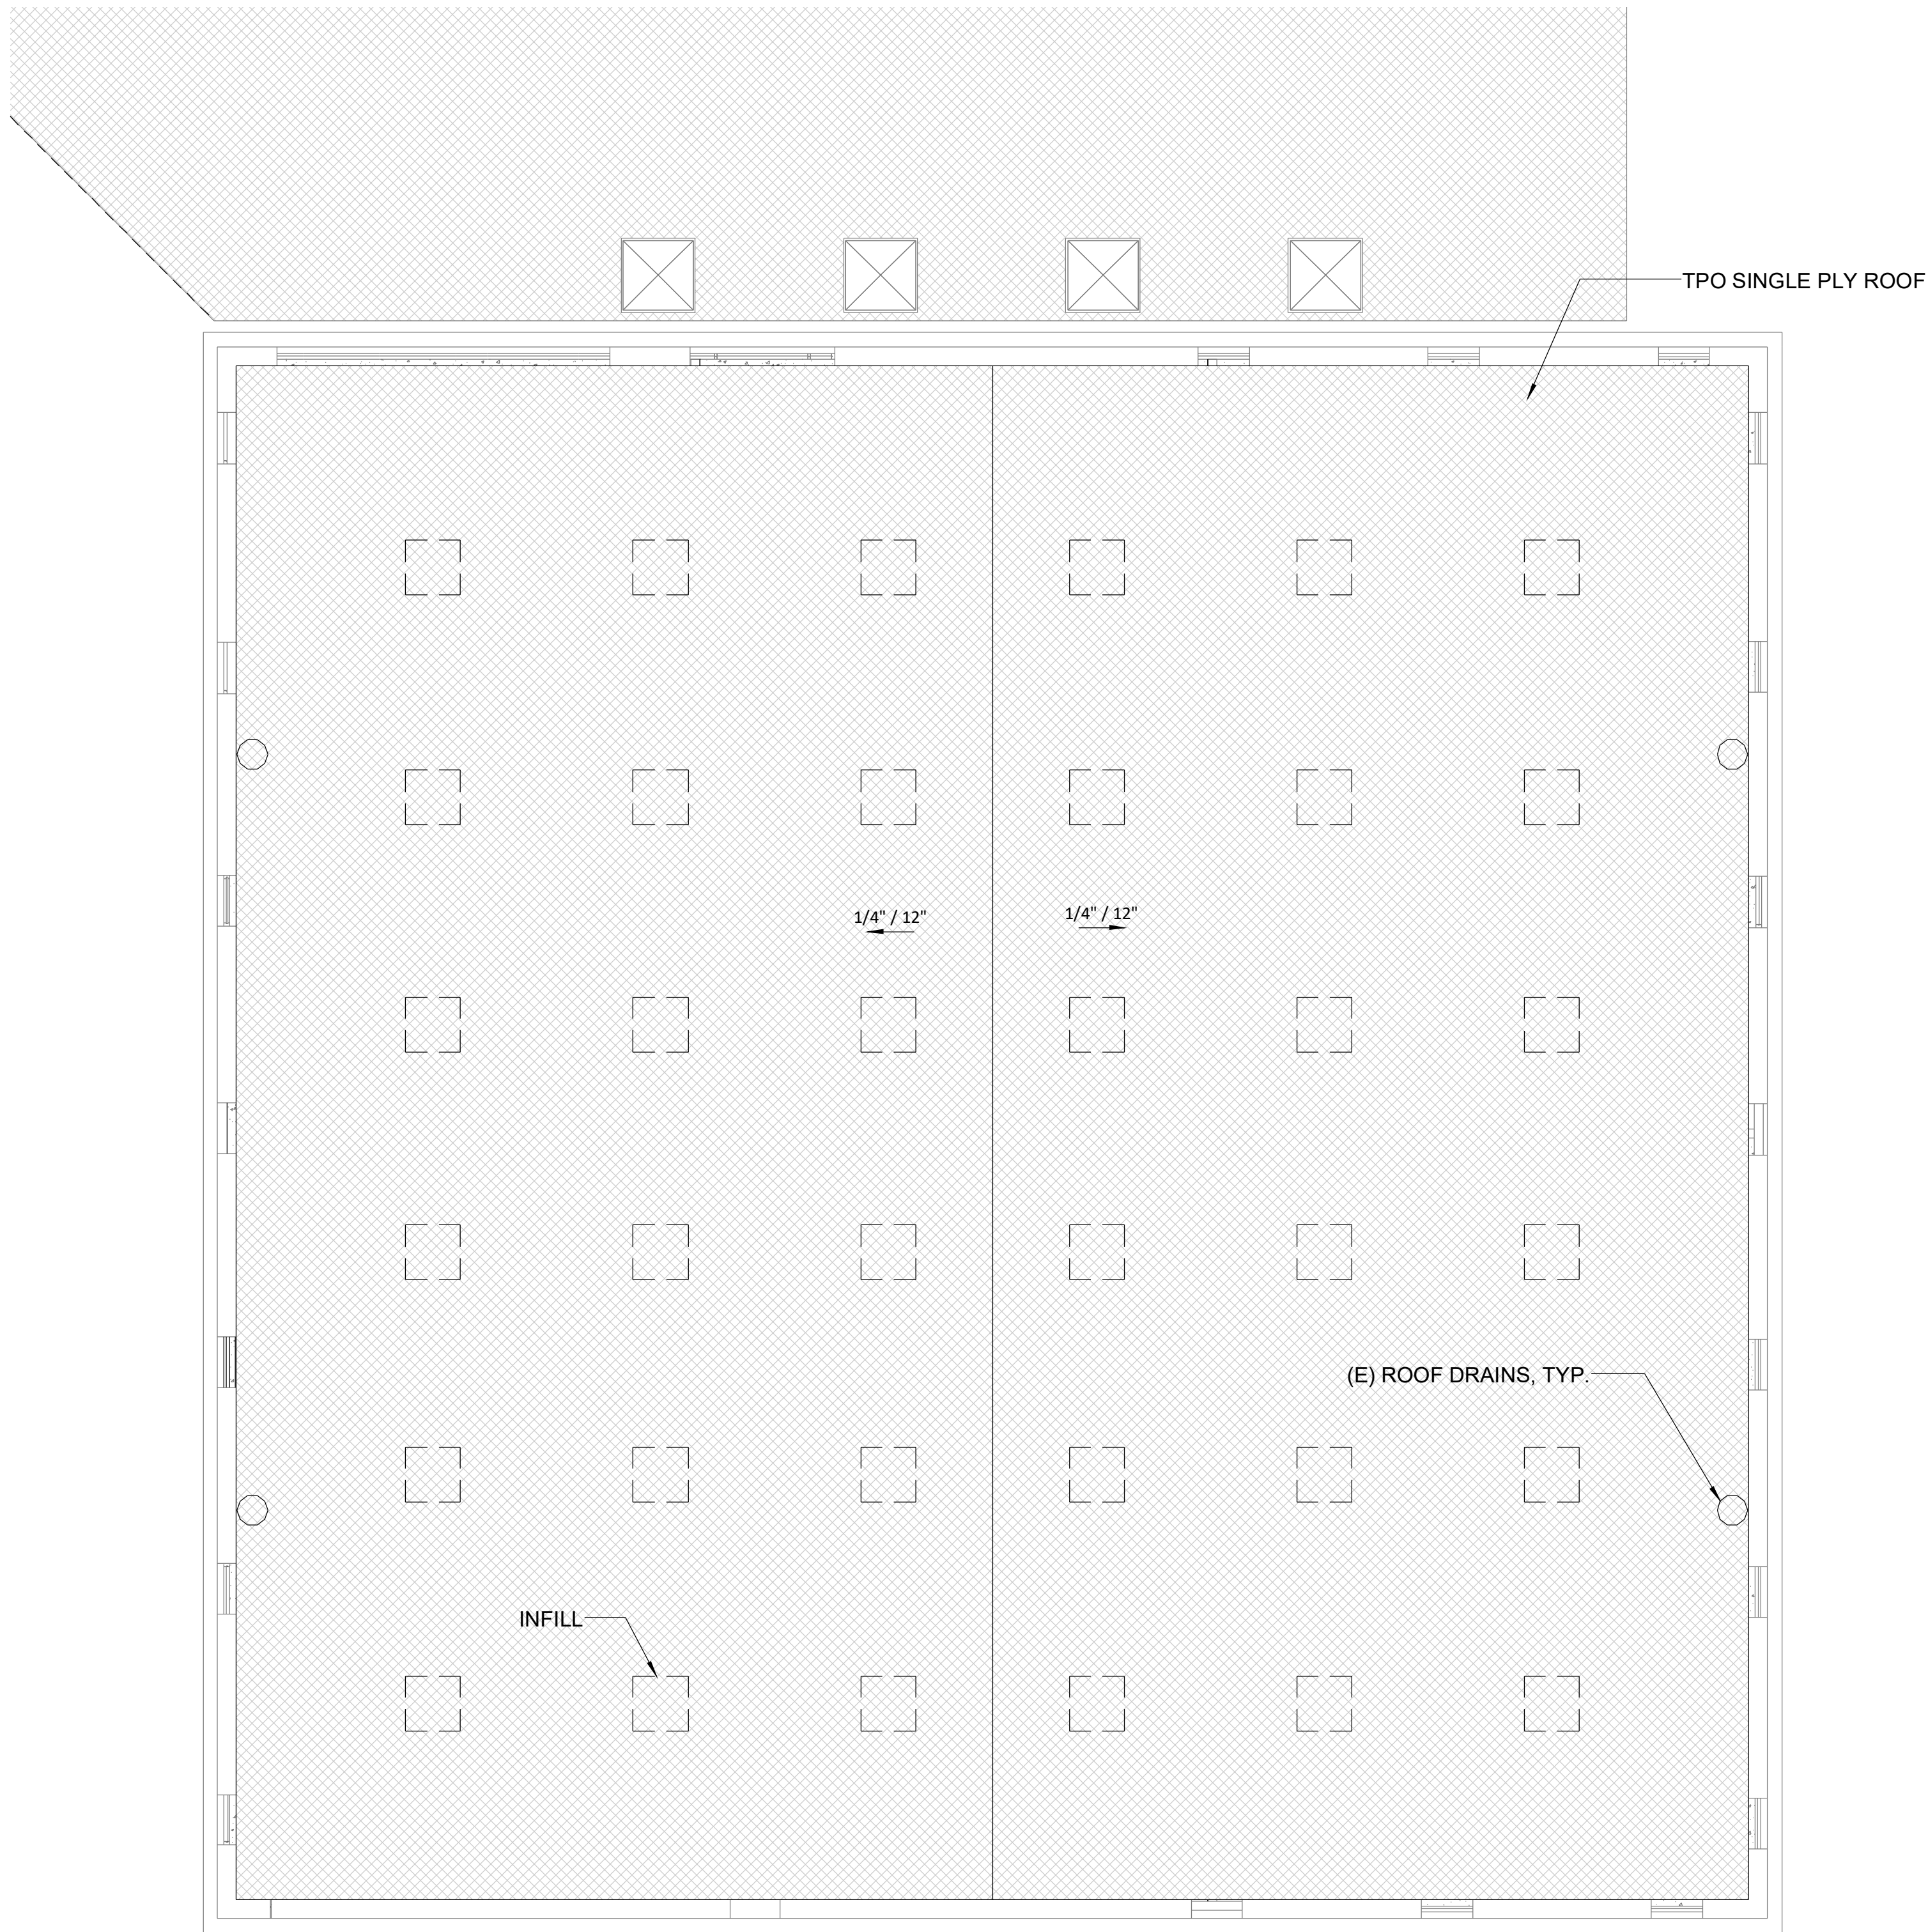

BUILDING M - IMPROVEMENT ROOF PLAN **1**  
1/8" = 1'-0"



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SHEET NAME:  
**BUILDING M - DEMOLITION & IMPROVEMENT ROOF PLAN**

**DESIGN DEVELOPMENT**

DATE: 4/15/2025  
CLIENT PROJ NO:

SHEET:

**AM4.11**

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## DESIGN DEVELOPMENT

CLIENT PROJ NO:


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## AM7.11




Autodesk Docs: 12371016000 Stockton USD Weber Institute Gymnasium 12371016000-A-WEBER-INST-SITE.rvt 4/17/2025 7:00:41 AM


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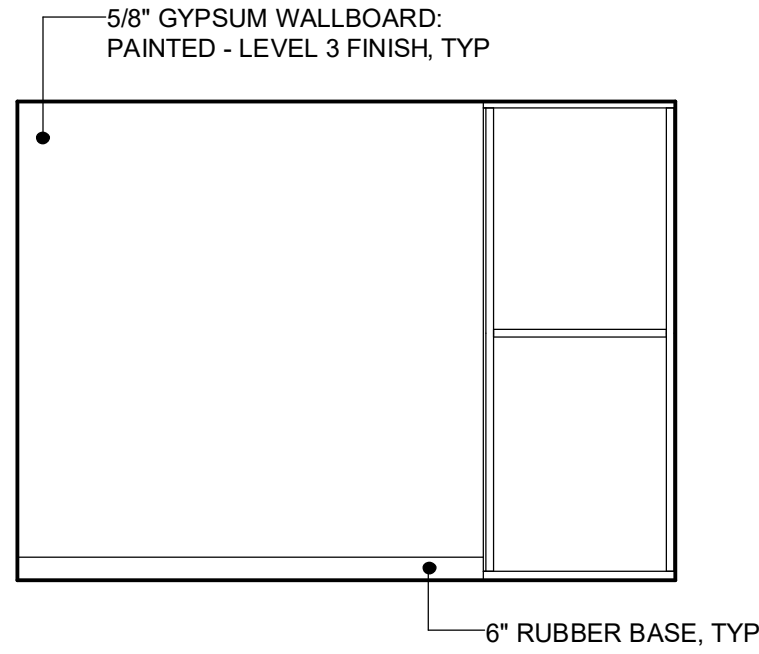
113 OFFICE 4 **5D**  
1/4" = 1'-0"

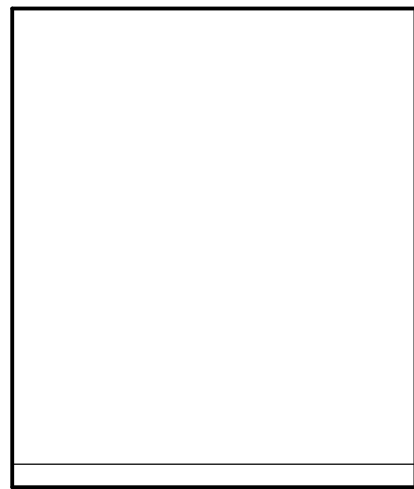


113 OFFICE 3 **5C**  
1/4" = 1'-0"

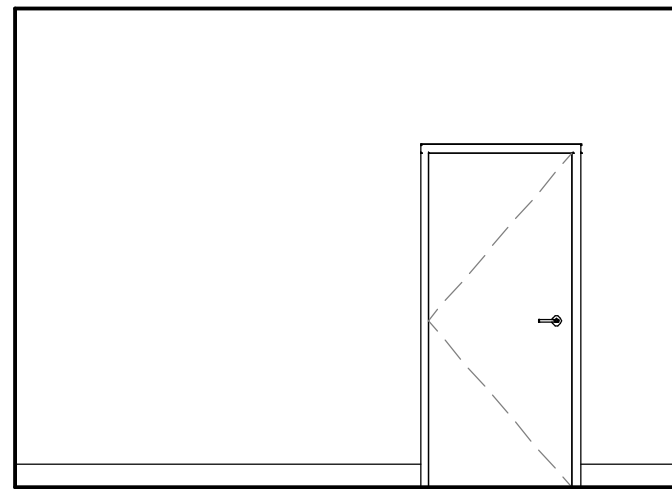


113 OFFICE 2 **5B**  
1/4" = 1'-0"

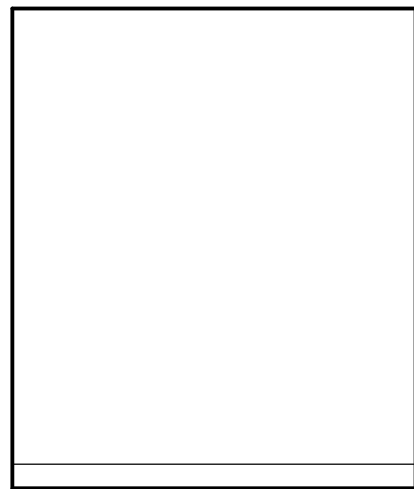


113 OFFICE 1 **5A**  
1/4" = 1'-0"

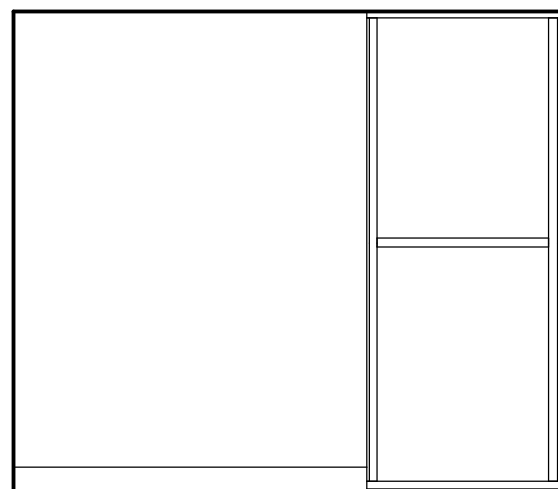


112 OFFICE 4 **4D**  
1/4" = 1'-0"

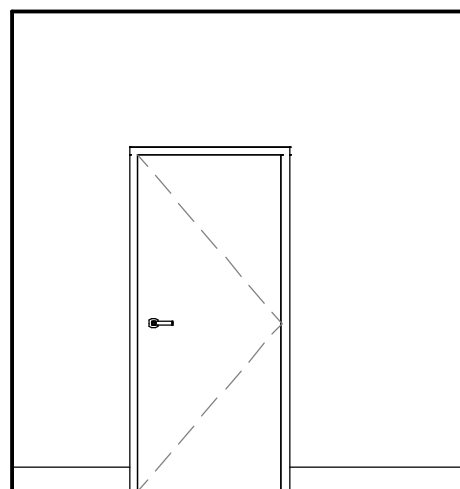


112 OFFICE 3 **4C**  
1/4" = 1'-0"

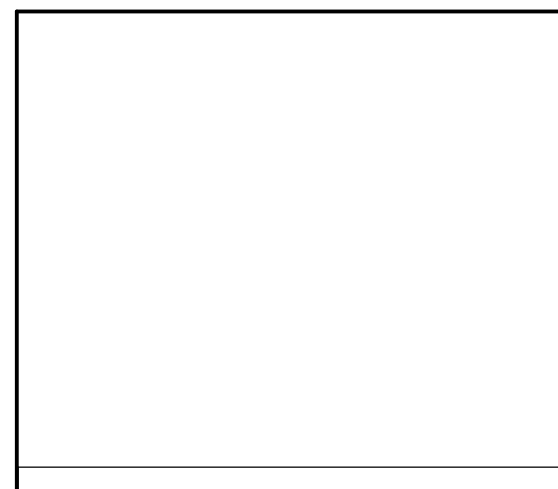


112 OFFICE 2 **4B**  
1/4" = 1'-0"

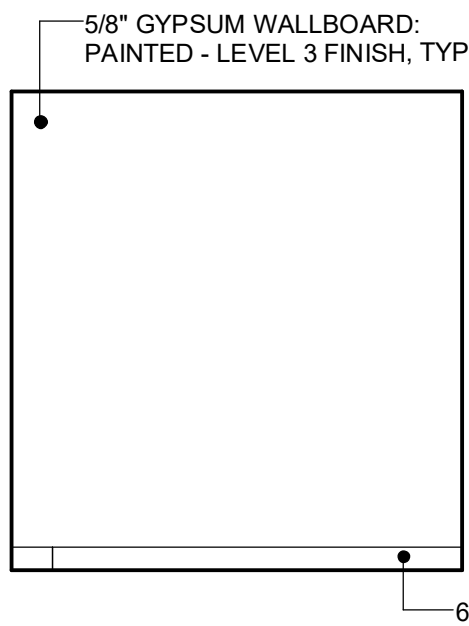


112 OFFICE 1 **4A**  
1/4" = 1'-0"

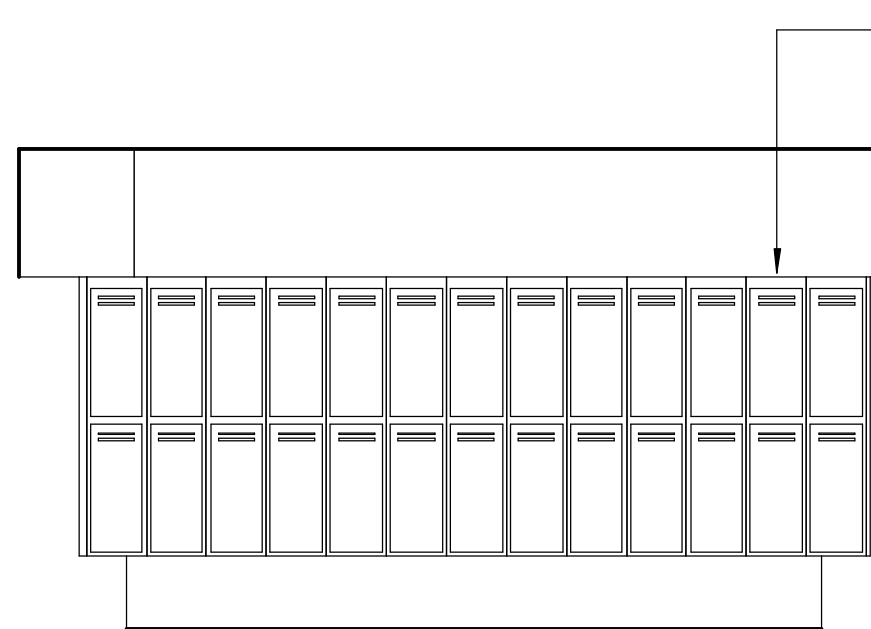


111 CHANGING ROOM 4 **3D**  
1/4" = 1'-0"

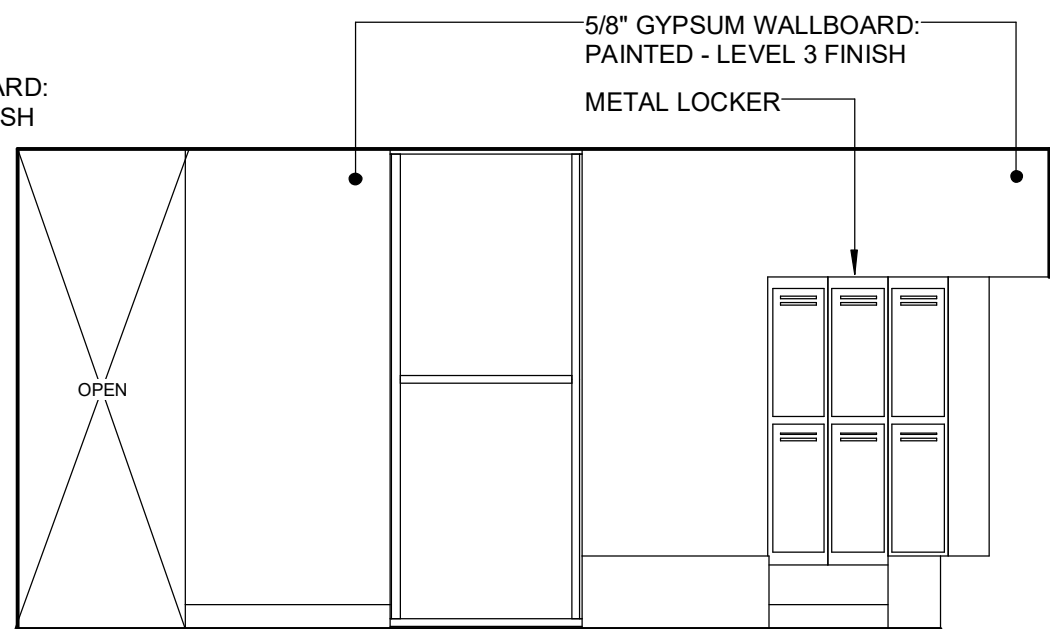


111 CHANGING ROOM 3 **3C**  
1/4" = 1'-0"

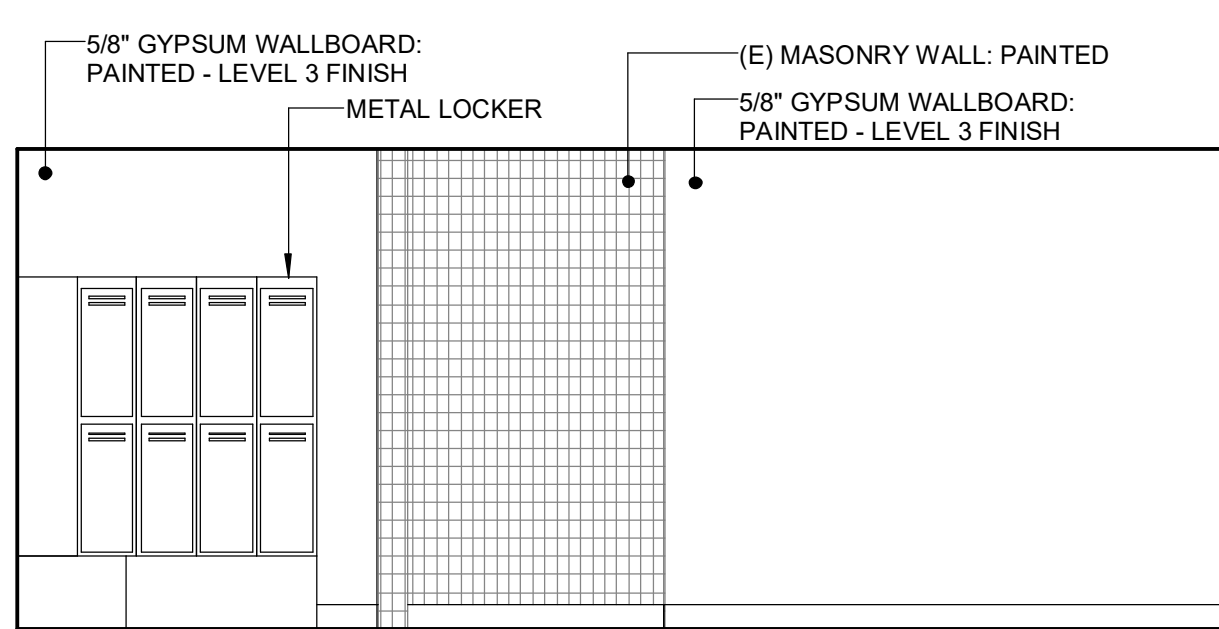


111 CHANGING ROOM 2 **3B**  
1/4" = 1'-0"

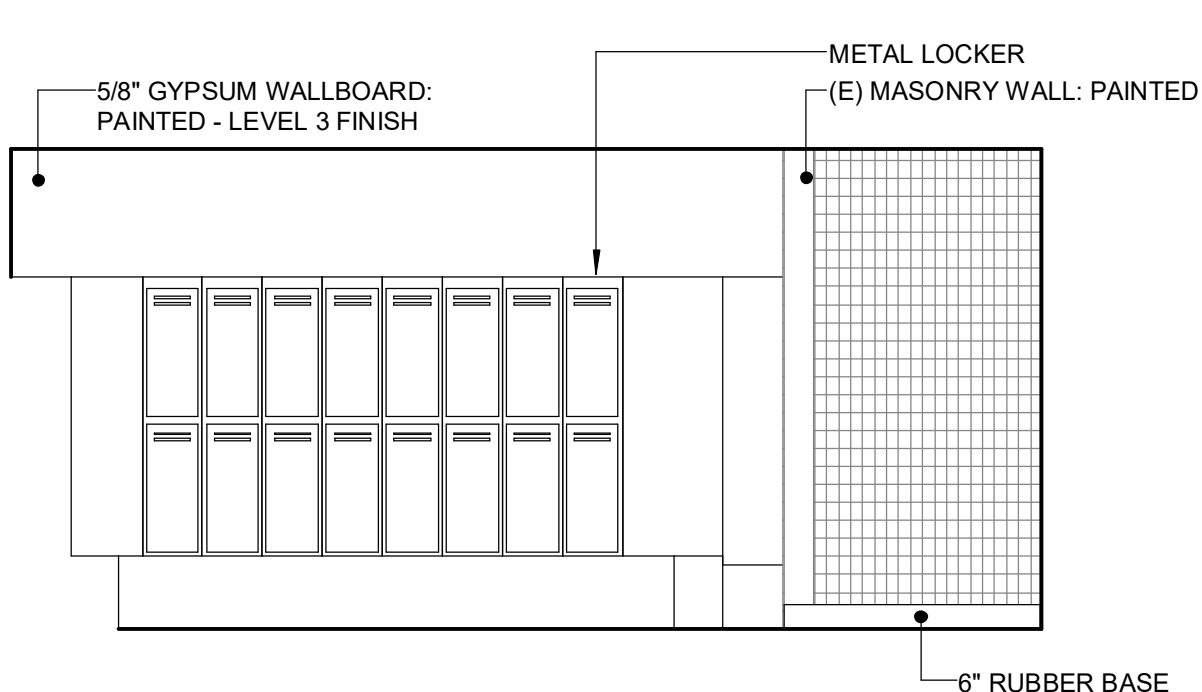


111 CHANGING ROOM 1 **3A**  
1/4" = 1'-0"

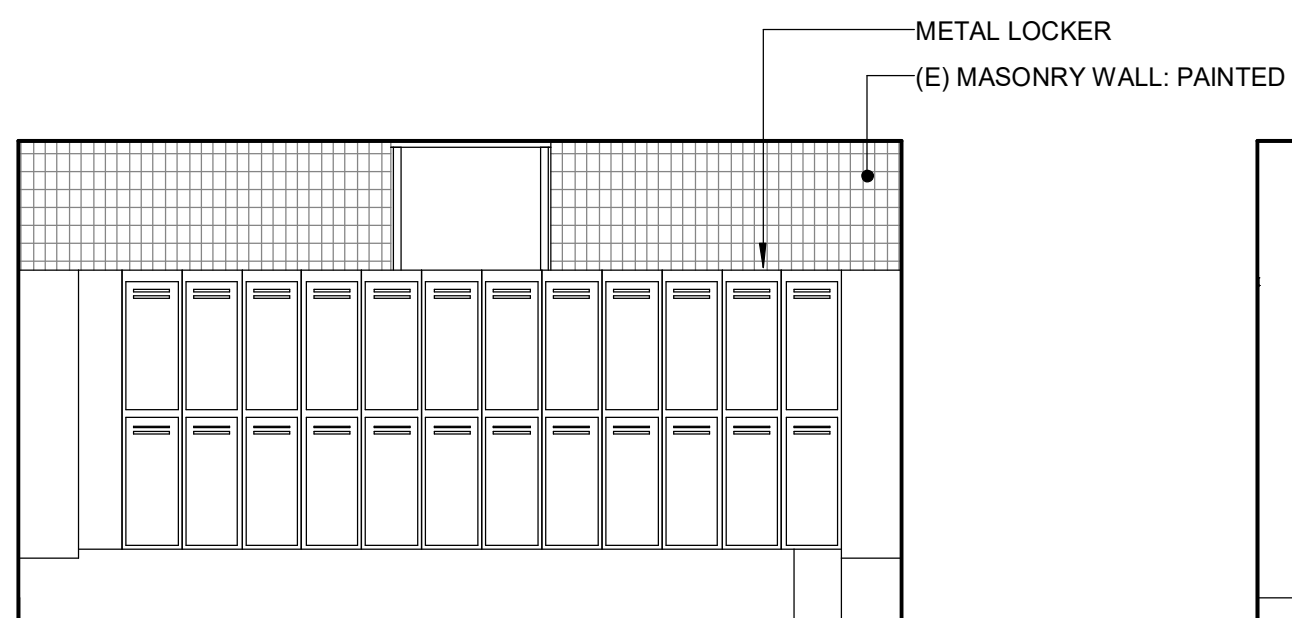


110 CHANGING ROOM 4 **2D**  
1/4" = 1'-0"

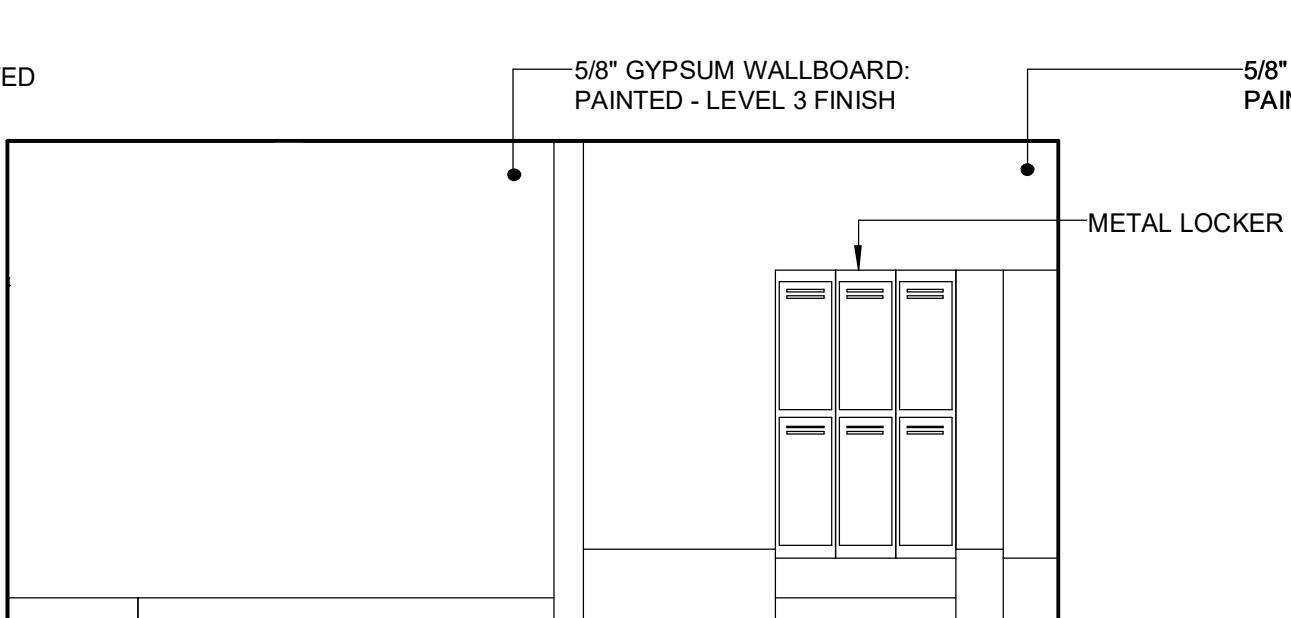


110 CHANGING ROOM 3 **2C**  
1/4" = 1'-0"

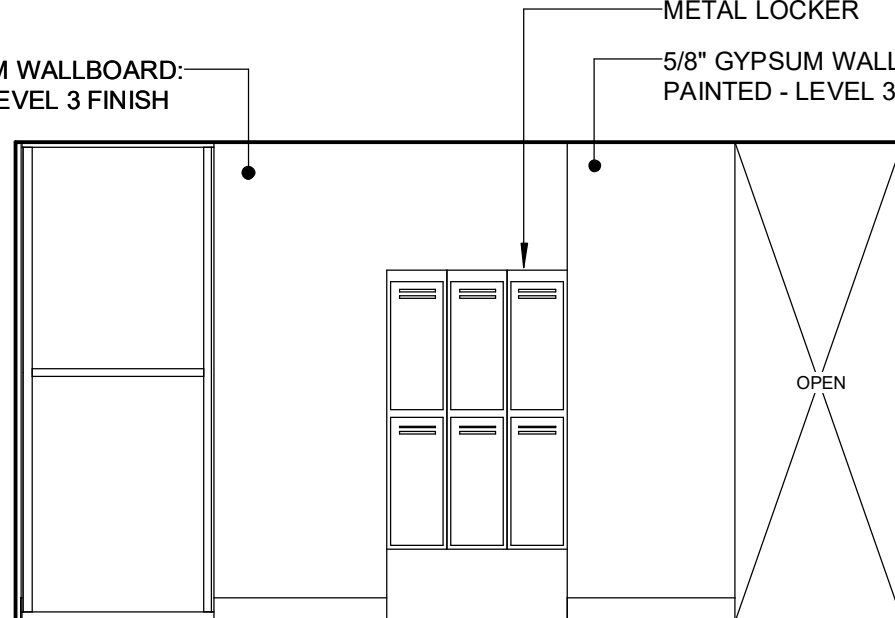


110 CHANGING ROOM 2 **2B**  
1/4" = 1'-0"

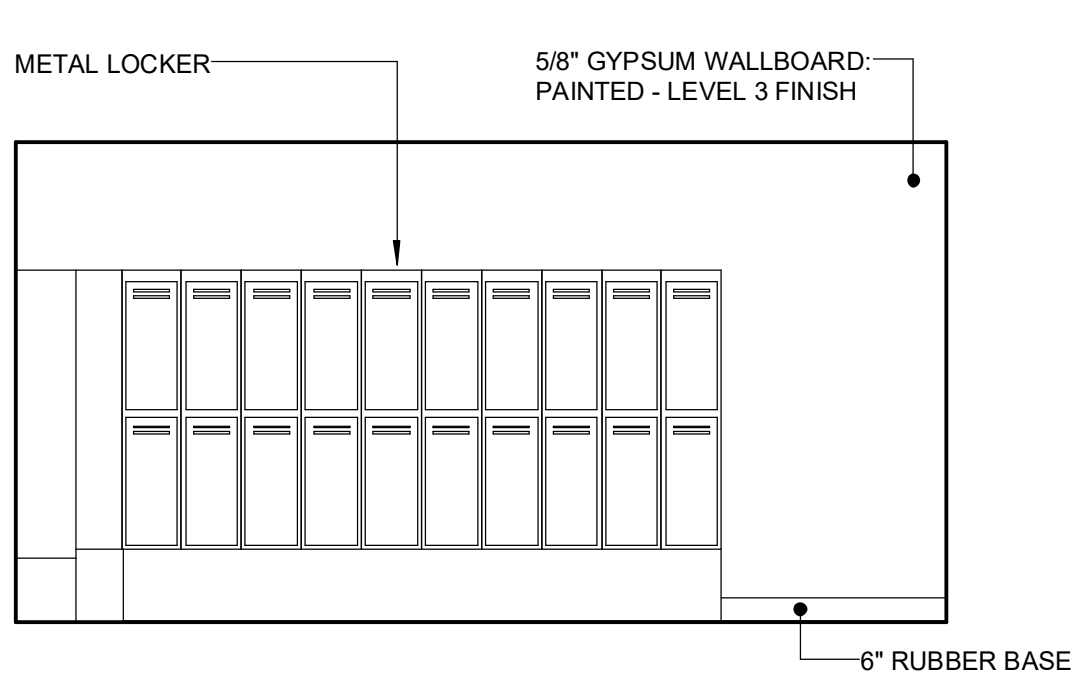


110 CHANGING ROOM 1 **2A**  
1/4" = 1'-0"

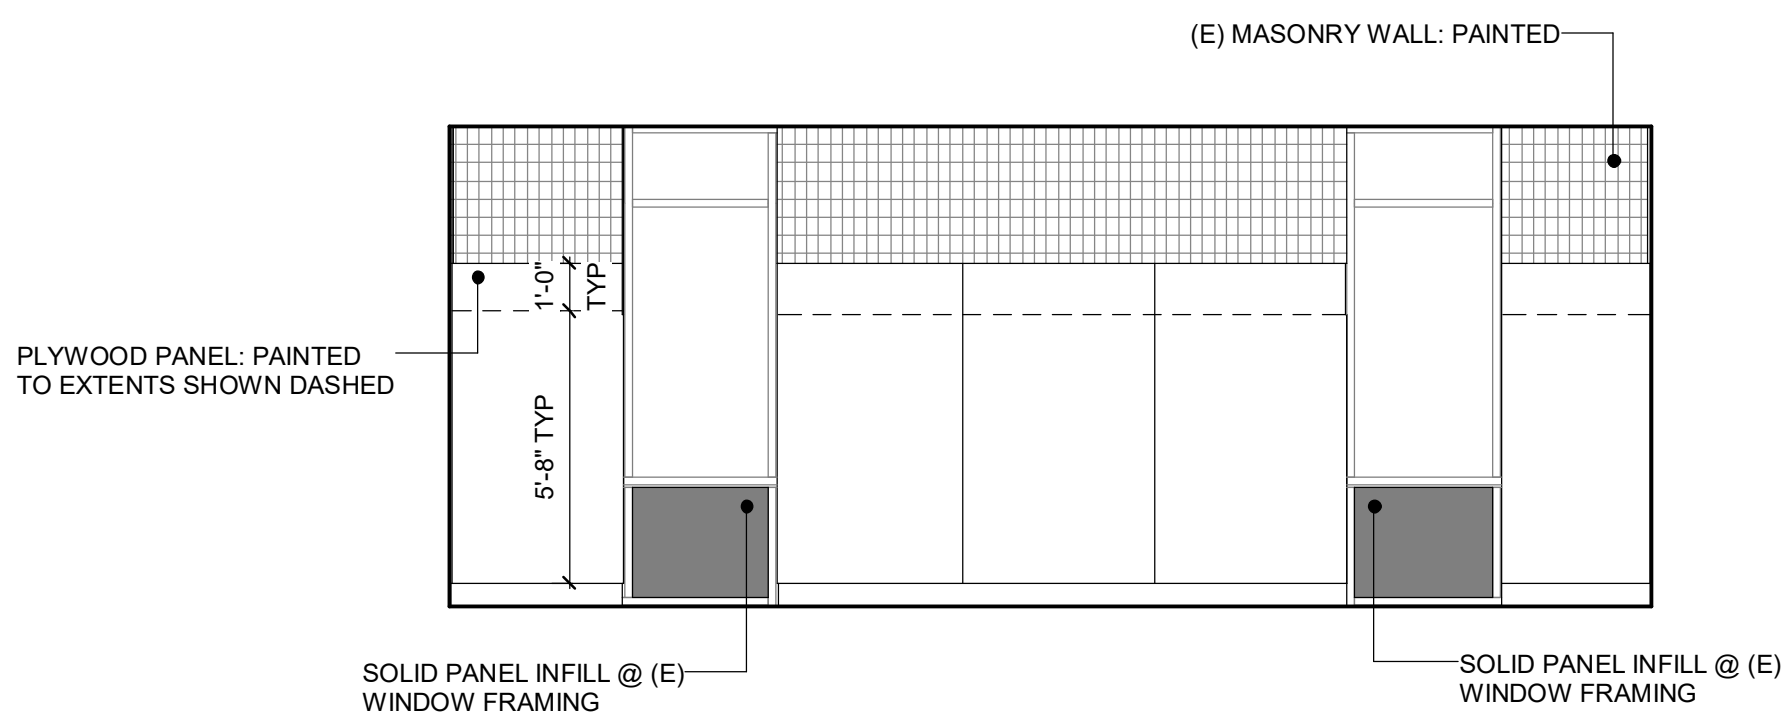


109 WEIGHT ROOM 4 **1D**  
1/4" = 1'-0"

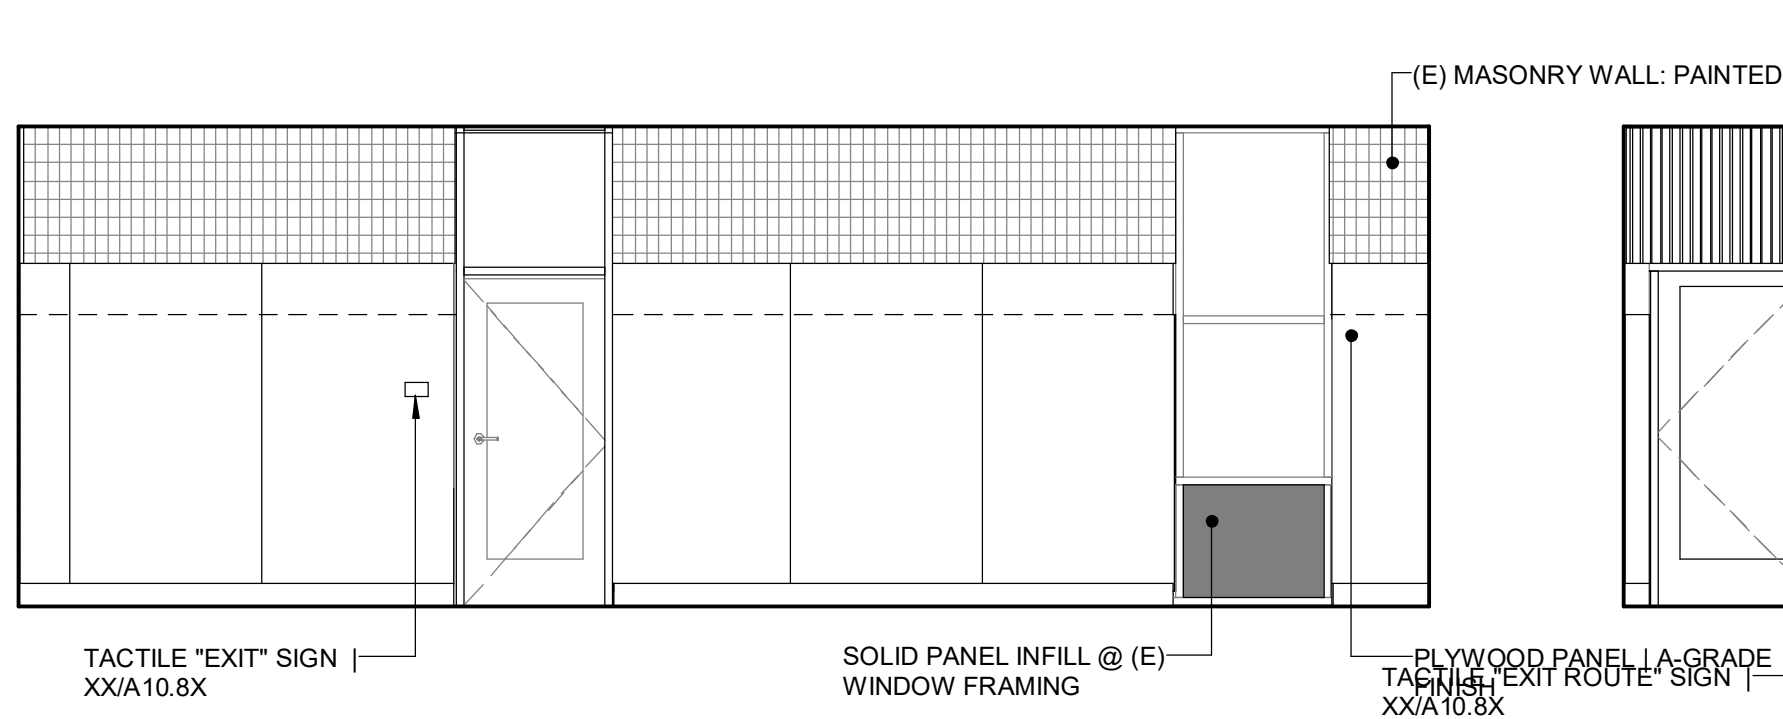

109 WEIGHT ROOM 3 **1C**  
1/4" = 1'-0"

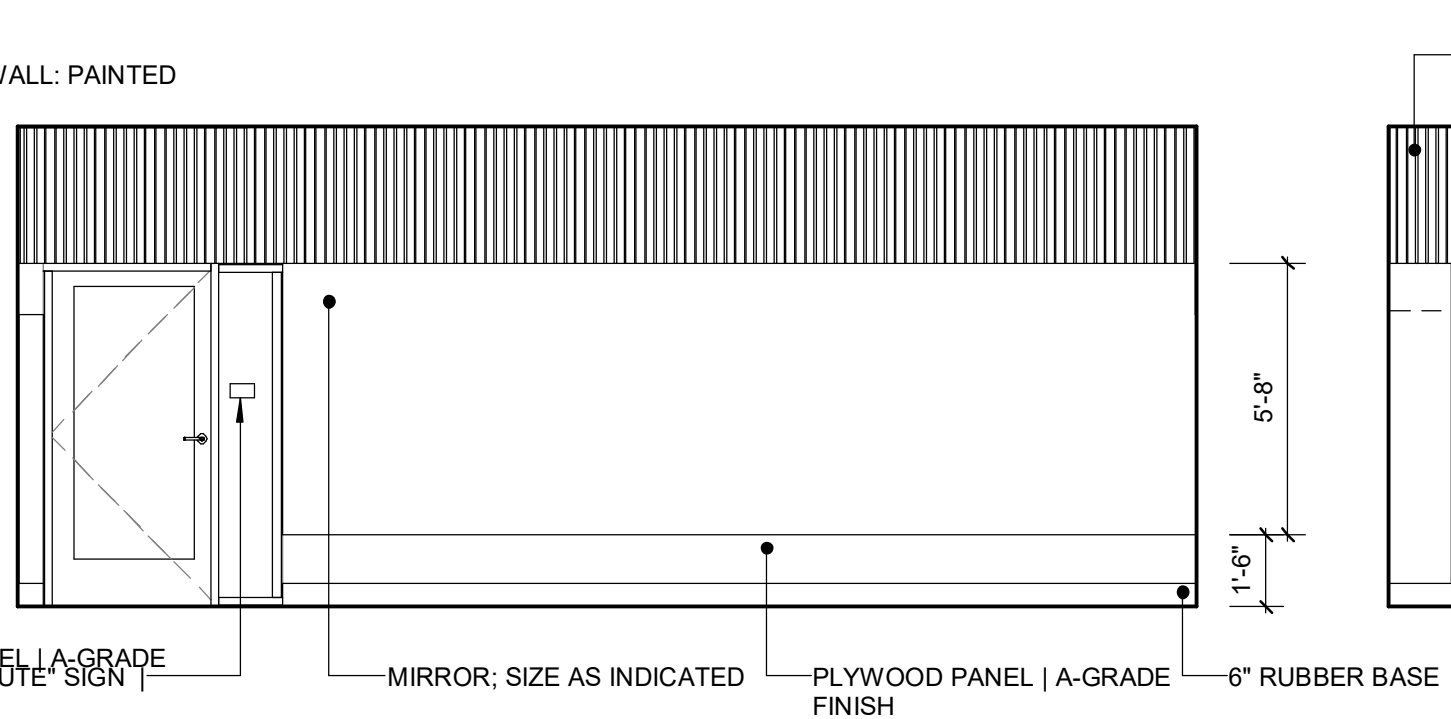

109 WEIGHT ROOM 2 **1B**  
1/4" = 1'-0"

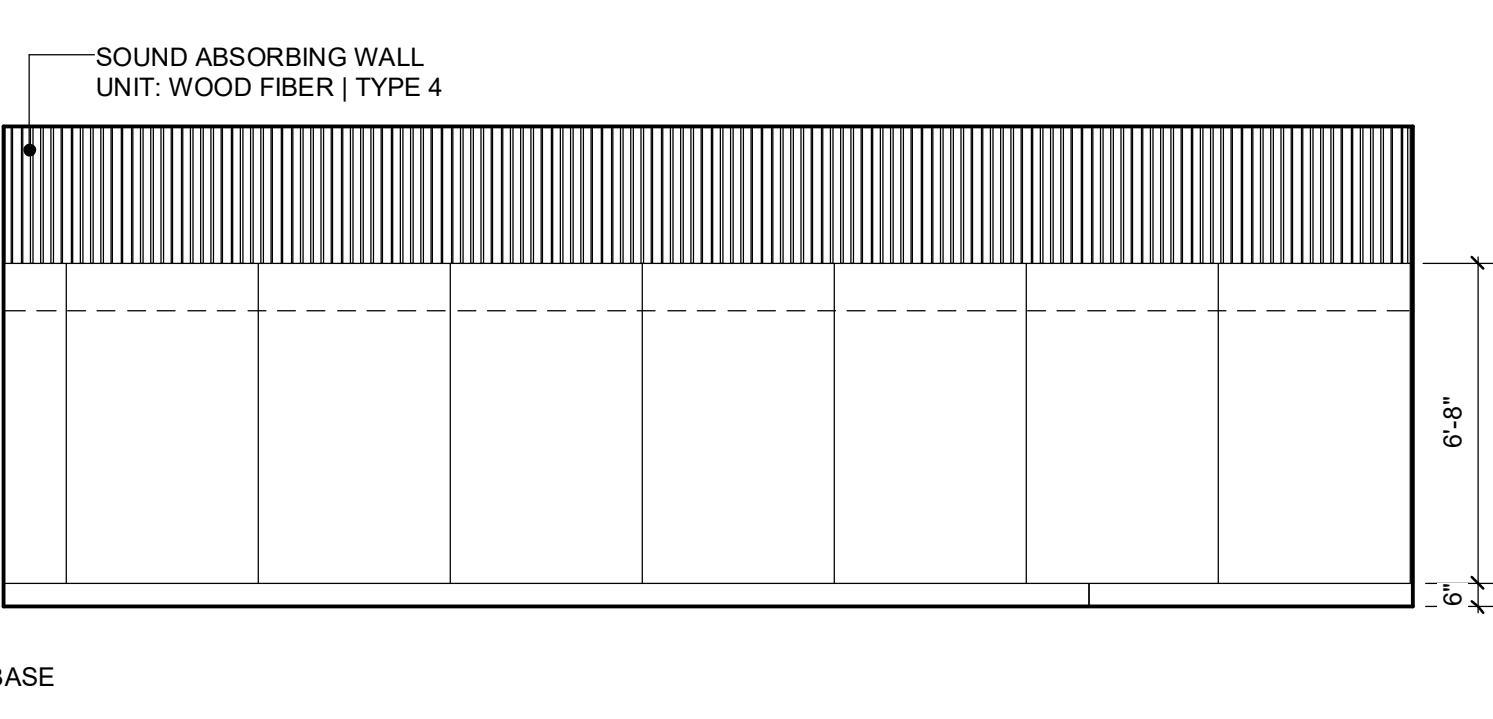

109 WEIGHT ROOM 1 **1A**  
1/4" = 1'-0"



**DESIGN FOR GOOD**  
**HMC Architects**  
3271-016-000  
2101 CAPITOL AVENUE, SUITE 100,  
SACRAMENTO, CA 95816  
916.368.7950 / www.hmcarchitects.com

**ISSUE**

DESCRIPTION	DATE
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#### KEYNOTES

#### NOTES

FACILITY:  
**WEBER INSTITUTE OF APPLIED SCIENCES & TECHNOLOGY**  
302 W WEBER AVE,  
STOCKTON, CA 95203

PROJECT:  
**STOCKTON USD WEBER INSTITUTE GYMNASIUM**

SHEET NAME:  
**BUILDING M - INTERIOR ELEVATIONS**

#### DESIGN DEVELOPMENT


DATE: 4/15/2025  
CLIENT PROJ NO:

SHEET:


AM8.10

Autodesk Docs: 12371016000 Stockton USD Weber Institute Gymnasium 12371016000-A-WEBER-INST-SITE.rvt  
4/17/2025 7:30:43 AM


THE LINE SHOWN ABOVE THE  
FOOTING IS NOT TO SCALE  
SHEET ORIGINAL PAGE SIZE

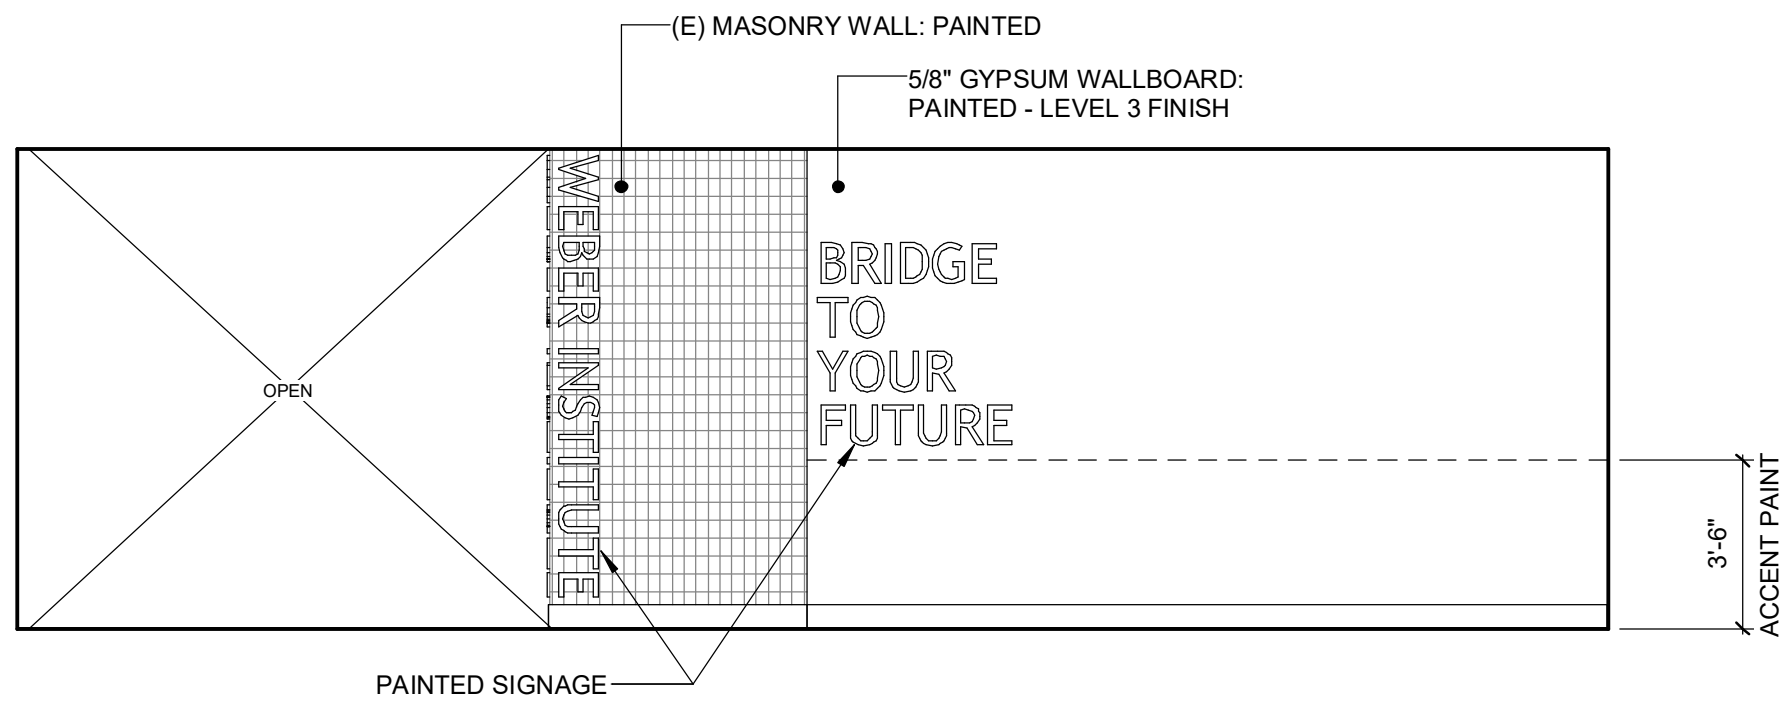


123 CORRIDOR 1F  
1F  
1/4" = 1'-0"

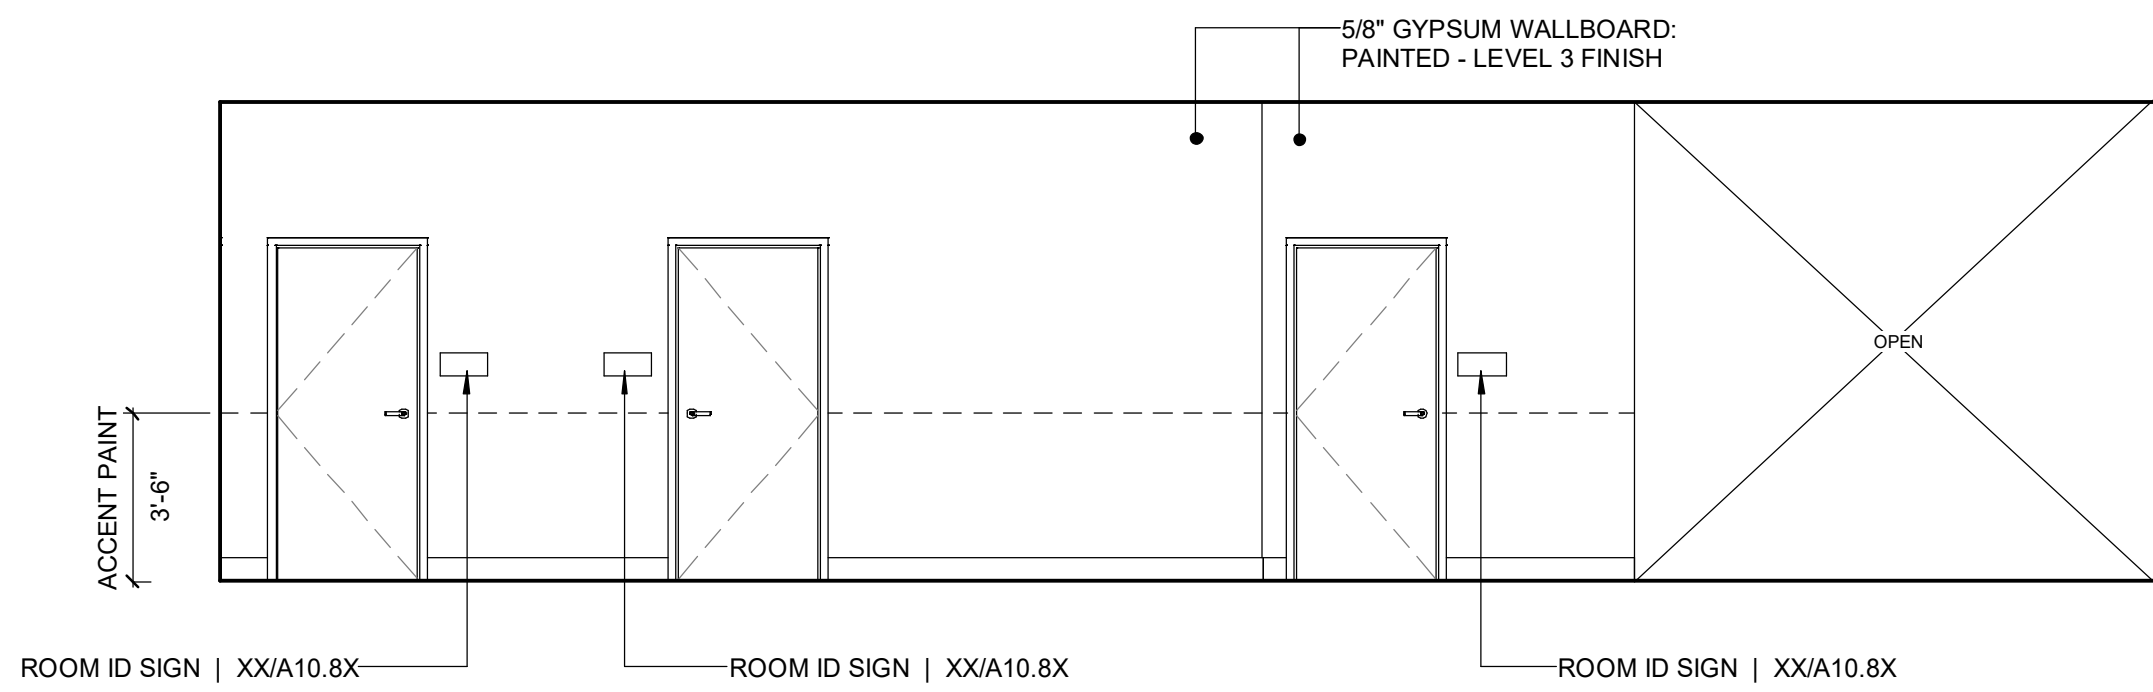

123 CORRIDOR 1E  
1E  
1/4" = 1'-0"

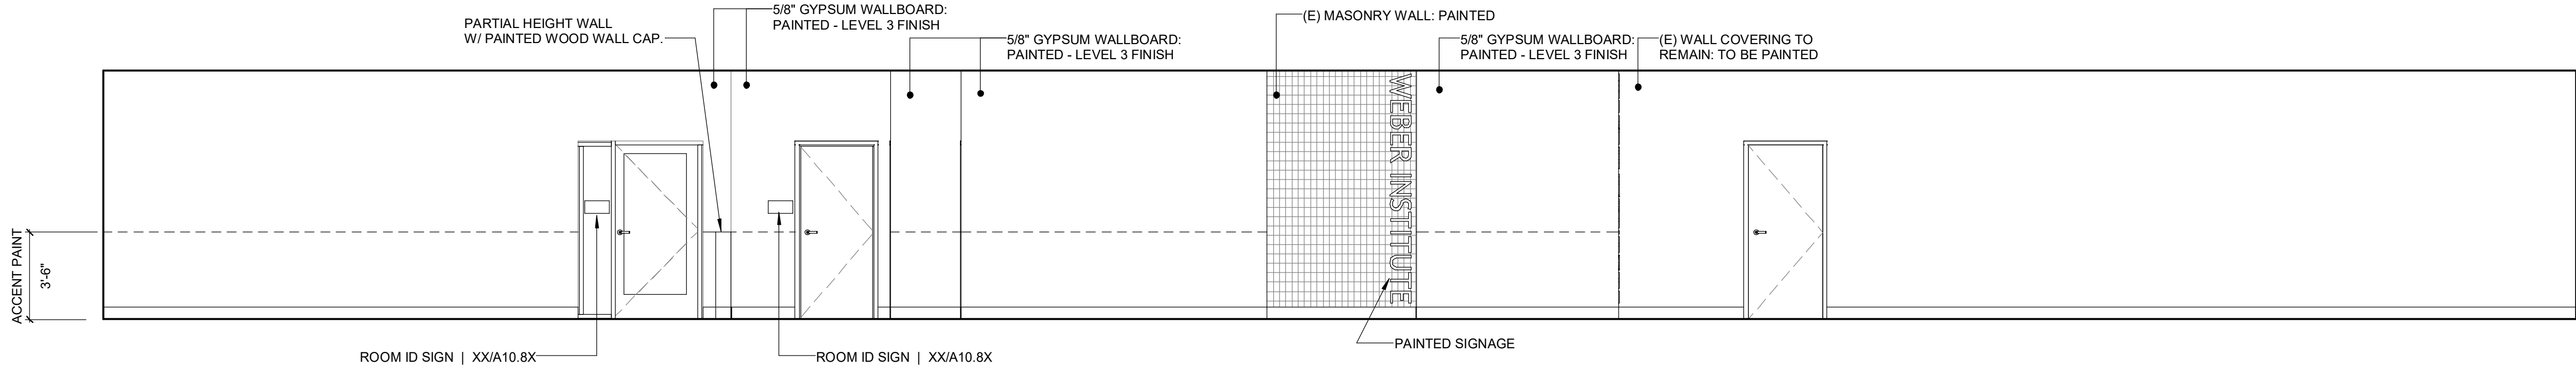


123 CORRIDOR 1D  
1D  
1/4" = 1'-0"

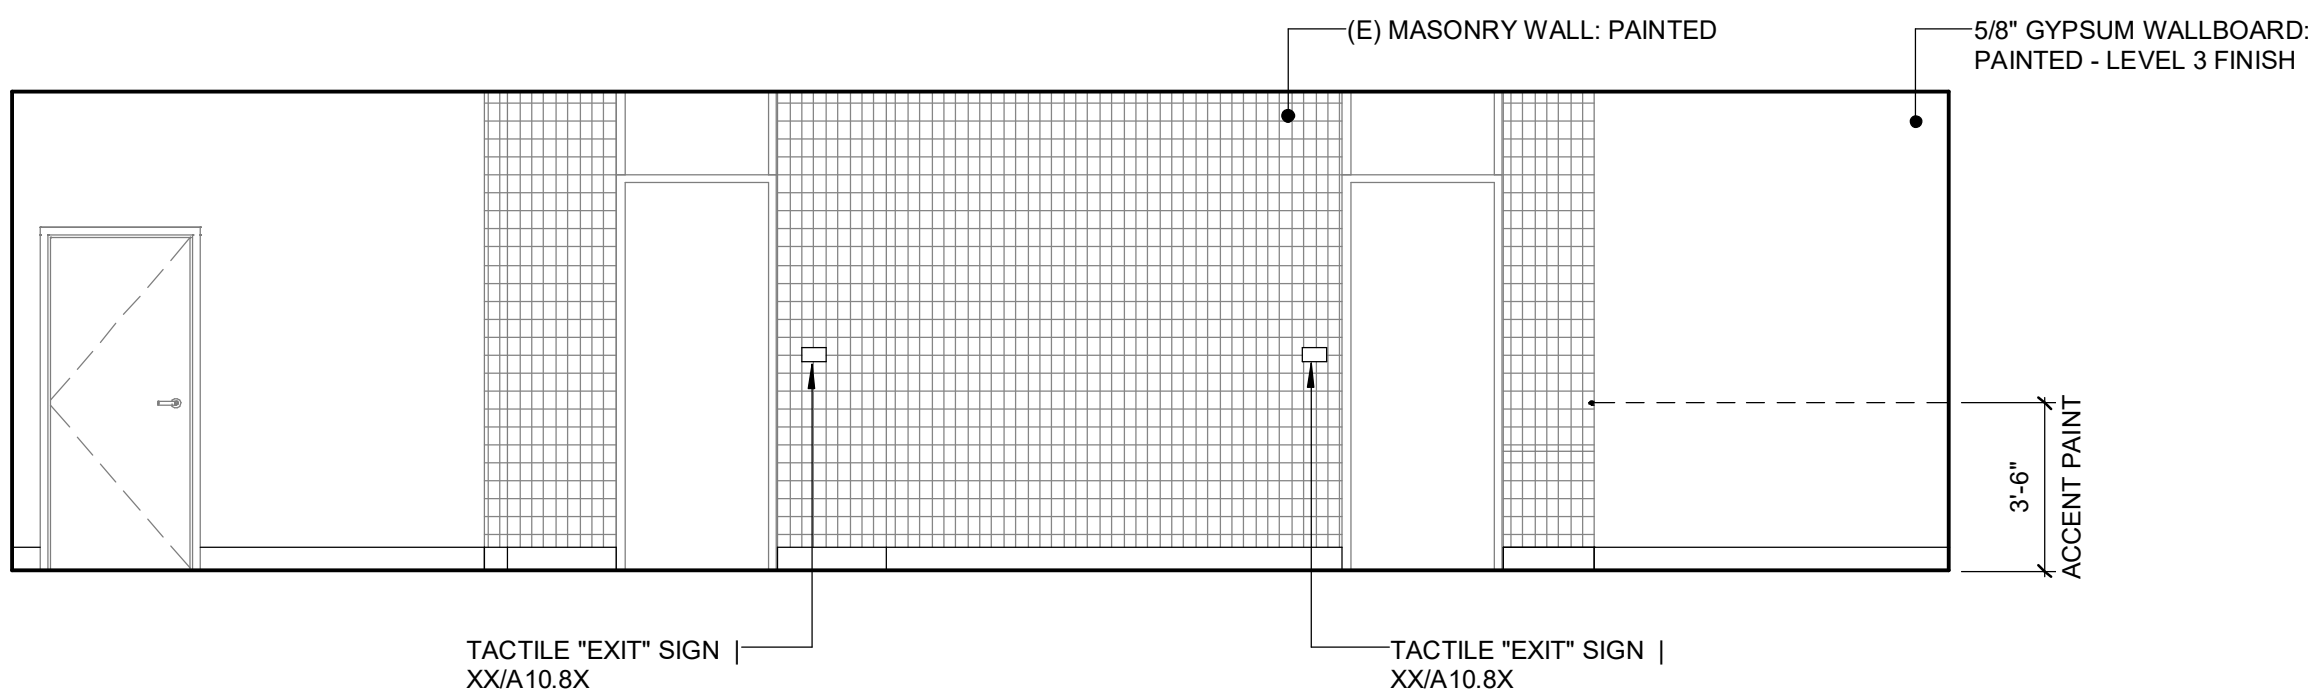

123 CORRIDOR 1C  
1C  
1/4" = 1'-0"



123 CORRIDOR 1B  
1B  
1/4" = 1'-0"

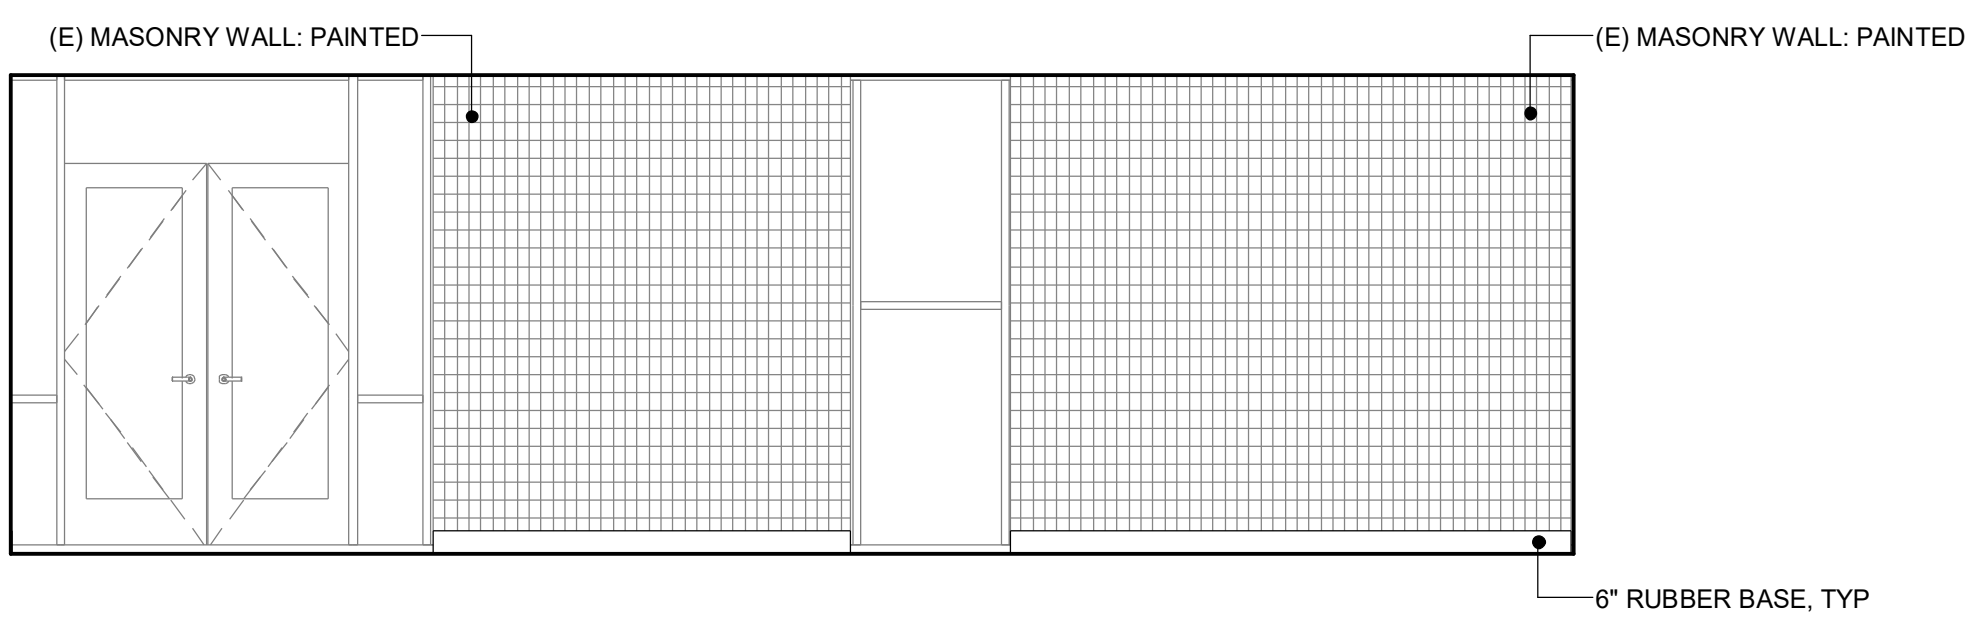

123 CORRIDOR 1A  
1A  
1/4" = 1'-0"



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**ISSUE**

DESCRIPTION	DATE
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**NOT FOR CONSTRUCTION**

KEYNOTES

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BUILDING M - INTERIOR ELEVATIONS

**DESIGN DEVELOPMENT**

DATE: 4/15/2025  
CLIENT PROJ NO:

SHEET:

AM8.11